

CITY OF OWOSSO PLANNING COMMISSION Regular Meeting Monday, December 13, 2021 at 6:30 p.m. AGENDA

- A. CALL TO ORDER
- **B. PLEDGE OF ALLEGIANCE**
- C. ROLL CALL
- D. APPROVAL OF AGENDA December 13, 2021
- E. APPROVAL OF MINUTES November 22, 2021
- F. ELECTION OF OFFICERS if necessary (due in July 2022)
- G. PUBLIC HEARINGS: NONE
- H. SITE PLAN REVIEWS:
 - **1.** 1410/1420 Hathaway
- I. ITEMS OF BUSINESS:
- J. COMMISSIONER/CITIZEN COMMENTS:
- K. ADJOURNMENT

Next regular meeting will be on Monday, January 24, 2022 at 6:30 p.m.

The City of Owosso will provide necessary reasonable auxiliary aids and services, such as signers for the hearing impaired and recordings of printed materials being considered at the meeting, to individuals with disabilities at the meeting/hearing upon seventy-two (72) hours' notice to the City of Owosso. Individuals with disabilities requiring auxiliary aids or services should contact the City of Owosso by writing or calling the following: Amy Kirkland, City Clerk, 301 W. Main St, Owosso, MI 48867 (989) 725-0500. The City of Owosso website is: www.ci.owosso.mi.us

MINUTES REGULAR MEETING OF THE OWOSSO PLANNING COMMISSION Monday, November 22, 2021 – 6:30 P.M.

CALL TO ORDER: Chairman Wascher called the meeting to order at 6:30 p.m.

PLEDGE OF ALLEGIANCE: Recited

ROLL CALL: Recording Secretary Molly Hier

MEMBERS PRESENT: Secretary Fear, Commissioners Law, Morris, Robertson, Taylor,

Chairman Wascher

MEMBERS ABSENT: Commissioner Jenkins, Vice-Chair Livingston

OTHERS PRESENT: Planning and Building Director Tanya Buckelew

APPROVAL OF AGENDA:

MOTION BY COMMISSIONER ROBERTSON, SUPPORTED BY COMMISSIONER LAW TO APPROVE THE AGENDA FOR November 22, 2021.

YEAS ALL. MOTION CARRIED.

APPROVAL OF MINUTES:

MOTION BY SECRETARY FEAR SUPPORTED BY COMMISSIONER LAW TO APPROVE THE MINUTES FOR THE September 27, 2021 MEETING.

YEAS ALL. MOTION CARRIED.

PUBLIC HEARINGS:

Rezoning Request – PREZ 2021-05 JABB MANAGEMENT – 108 N Chipman Street

Planning & Building Director Tanya Buckelew explained the property was originally zoned industrial but was rezoned to B-3 in 2012 due to being combined with W. Main Street frontage. A lot split was approved at the 11/01/2021 City Council meeting. There is now one lot with frontage on W. Main Street and this lot with frontage on N. Chipman Street. The applicant will keep the B-3 zoning on the parcel fronting along W. Main Street. The applicant is requesting 108 N. Chipman Street be rezoned back to I-1 Light Industrial for the purpose of a marihuana grow facility.

Opened the Public Hearing at: 6:35 pm

The following commented:

Eugene and Dee Riley of 1106 Beehler Street objected to the rezoning and use of 108 N. Chipman being used as a marihuana grow facility. Concerned about potential smell and deterioration of property value in the area.

Travis Prince of 1203 W. Main Street objected to the rezoning and use of 108 N. Chipman being used as a marihuana grow facility.

The City received a letter from Julie Wenzlick of 1101 Riverside Drive regarding grow facilities in Owosso and the odor that exists in Chesaning.

Adam Bronson, owner of 108 N. Chipman Street, explained if rezoned to industrial his plans for the building are an allowable use, offered explanation on odor control.

Closed the Public Hearing at: 6:40 pm

Planning & Building Director Tanya Buckelew briefly explained the city ordinance and that outdoor grow is not allowed in the City and strict adherence to odor control is provided for in the ordinance.

Chairman Wascher expressed concern on adding more industrial zones in the City of Owosso, Commissioner Robertson agreed.

Commissioner Law commented in support to this rezoning and wants to see the building occupied.

The following review is from Justin Sprague, City Planner with CIB Planning:

The subject parcel is located along the east side of N. Chipman Street, adjacent to the rail line. The property is identified in the draft master plan as an area for redevelopment but did not specifically state what redevelopment should be. The applicant would like to potentially locate a marijuana growing facility on this property.

	EXISTING LAND USE	ZONING	MASTER PLAN		
Subject Site Existing 26,000 SF Industrial E		B-3 Commercial	Commercial		
	Building				
North	Industrial & Commercial	B-3 Commercial	Commercial		
South	Commercial	B-3 Commercial	Commercial		
East	Commercial	B-3 Commercial	Commercial		
West	Industrial & Commercial	B-4 General Commercial	Local business and		
		and I-1 Light Industrial	industrial		

In considering any petition for an amendment to the official zoning map, the planning commission and city council shall consider the following criteria in making its findings, recommendations, and decision:

- 1. Consistency with the goals, policies, and future land use map of the City of Owosso Master Plan. If conditions upon which the master plan was developed (such as market factors, demographics, infrastructure, traffic and environmental issues) have changed significantly since the master plan was adopted, as determined by the city, the planning commission and council shall consider the consistency with recent development trends in the area. Finding While the current future land use map identifies this area as commercial, this property was previously industrial, and a marijuana grow facility would not be considered too intense for the surrounding commercial uses.
- Compatibility of the site's physical, geological, hydrological, and other environmental features with the host of uses permitted in the proposed zoning district.
 Finding This site would be compatible with the host of uses permitted under the I-1 Zoning Classification.
- 3. Evidence the applicant cannot receive a reasonable return on investment through developing the property with at least one (1) use permitted under the current zoning.

<u>Finding – To our knowledge, no evidence exists showing that the applicant could not receive a reasonable return on investment through developing the property as commercial.</u>

4. The compatibility of all the potential uses allowed in the proposed zoning district with surrounding uses and zoning in terms of land suitability, impacts on the environment, density, nature of use, traffic impacts, aesthetics, infrastructure and potential influence on property values.

<u>Finding – It is our belief that land uses within the I-1 district are more compatible with</u> this site given former industrial uses on this site and the proximity to the rail line.

- 5. The capacity of the city's infrastructure and services sufficient to accommodate the uses permitted in the requested district without compromising the "health, safety, and welfare."
 Finding There should be no issues with existing infrastructure being able to accommodate and service this site.
- 6. The apparent demand for the types of uses permitted in the requested zoning district in relation to the amount of land currently zoned and available to accommodate the demand. Finding We find that there is high demand for industrial property in Owosso for potential marijuana grow facilities. There is already an approved facility across the street on Hathaway Drive and this site makes sense to revert back to its industrial nature.
- 7. The request has not previously been submitted within the past one (1) year, unless conditions have changed, or new information has been provided.

 Finding This application has not been previously before the City.

Based upon the above comments, we recommend approval of the rezoning request for 108 N. Chipman based on the following items:

- 1. That the request is not in overwhelming conflict with the Master Plan or the Zoning Ordinance;
- 2. The site is compatible with uses in the proposed I-1 Zoning District;
- 3. The applicant is not rezoning to increase the return on investment of the property;
- 4. That the Planning Commission understands that the proposed use may be more compatible with surrounding land uses;
- 5. Infrastructure to the site is appropriate for the proposed use; and
- 6. The request has not been previously submitted to the City for consideration.

MOTION BY COMMISSIONER LAW SUPPORTED BY SECRETARY FEAR TO APPROVE THE REZONING OF THE FOLLOWING PROPERTY:

ADDRESS	PARCEL ID NUMBER	APPROVED REZONING
108 N CHIPMAN ST	050-660-017-001-00	I-1 LIGHT INDUSTRIAL DISTRICT

YEAS: SECRETARY FEAR, COMMISSIONER LAW, COMMISSIONER MORRIS,

COMMISSIONER TAYLOR

NAYS: COMMSSIONER ROBERTSON, CHAIRMAN WASCHER

RCV: 4-2 MOTION CARRIED

ITEMS OF BUSINESS: NONE

COMMISSIONER/CITIZEN COMMENTS: NONE

ADJOURNMENT:

MOTION BY COMMISSIONER MORRIS SUPPORTED BY SECRETARY FEAR TO ADJOURN AT 7:05 PM UNTIL THE NEXT MEETING ON DECEMBER 13, 2021.

YEAS ALL, MOTION CARRIED

Janae Fear, Secretary



CITY OF OWOSSO, MICHIGAN SITE PLAN REVIEW APPLICATION AND CHECKLIST

- Application must be filed at least 25 days prior to a scheduled Planning Commission meeting for staff review and proper notices.
- > This application is submitted with 1 copy of the complete site plan and appropriate fees. Applicant shall also submit a digital version of the site plan.
- Accompanying any site plan required hereunder, the applicant shall provide from, a licensed engineer, soil borings at the proposed construction site to ascertain bearing capacity of foundations soils at the time of footing excavation to certify such soil conditions meet or exceed design capacity of the foundation to support the proposed structure. These requirements shall comply with policies of the City of Owosso, copies of which can be obtained from the Building Department.
- The attached checklist has been completed to certify the data contained on the site plan. If the required data has not been provided, the appropriate box has been checked with a statement of explanation on why the data has not been provided.
- I understand that if my site plan is deemed to be incomplete, it may be returned by the City for revisions without being forwarded to the Planning Commission for consideration, until such time as the requirements have been adequately met.
- By signing this application, the applicant hereby grants full authority to the City of Owosso, its agents, employees, representatives and/or appointees to enter upon the undersigned lands/parcel(s) for the purposes of inspection and examination.

Appro	val of the site plan is hereby requested for the following parcel(s) of land in the City of Owosso.
Applic	ation Filed On: 1 - 10 - 202
Applic	ation Transmitted by City On:
Prope	rty Details:
1.	Name of Proposed Development:
2,	Property Street Address: 1426 Hathaway Dr Owosso, MI 48867
3.	Location of Property: On the (north, south, east, west side) of Street, between South East Side
4.	Legal Description of Property: SEE SITE PIAN
5.	Site Area (in acres and square feet): /.5/ acres
6.	Zoning Designation of Property: I-1
Owner	ship:
1.	Name of Title/Deed Holder: HD5 Investments LLC
2.	Address: 354 Westview Ave Columbus, OH 43214
3.	Telephone No: 614-296-7521
4.	Email address: alexander.m.close@gmail.com
Applic	ant:
1.	Applicant (If different from owner above):

Rev. December 2020

2. Address:								
3. Telephone No:								
4. Email address:								
5. Interest in Property (potential buyer/lease holder/potential lessee/other):								
Architect/Surveyor/Engineer preparing site plan:								
Name of Individual: Jessica A Marji								
2. Address: 25280 Ryan Road Warren	n, MI 48091							
3. Telephone No: 248.390.2243								
4. Email address: mcidesigngroup@gr	mail.com							
APPLICATION FEES:								
Apartment/townhouse	• \$550.00 + \$4.50/unit							
Commercial/Industrial	• \$500.00 + \$50.00/acre							
Institutional (Schools, Public Services, Hospitals)	• \$475.00 + \$40.00/acre							
Mobile home park	• \$575.00 + \$5.00/unit							
Planned Unit Development/Mixed use development	• \$550.00 + \$50.00/acre							
Preliminary site plan review	75% of site plan review fee							
Single family site condo (prelim or final)	• \$700.00 + \$5.00/lot							
Site plan revision/review	75% of site plan review fee + any needed consulting fees determined by administration							
Site plan requiring review by city engineer	all costs by owner/applicant via escrow							
Special meetings with planner/engineer	all costs by owner/applicant via escrow							
Escrow Fee	• \$1,500							
 Escrow Fee Consultant Fees for Planning, Zoning, Engineering & Related Reviews: To better enable the City of Owosso to provide the highest quality review services, it retains the assistance of specialized consultants on an as-needed basis. To ensure that these services do not negatively impact the City's general fund, the cost of said services is passed on to the applicants in the form of review fees and associated escrow accounts. 								
A cash deposit of \$1,500.00 shall be placed with the	City of Owosso to retain qualified consultants.							
	I funds are needed (typically when about 25% is remaining). Ir completion of the project, the balance will be remitted to the							
And Cha	11/4/21							
Signature of Applicant	Date							
	44/4/24							
M. Olla	11/4/21							
Signature of Deed/Title Holder	· Date							
PLEASE PROVIDE AN OVERVIEW OF THE PROJECT: 60' wide by 127' long by 17' high, agricultural post frame building Located at SouthEast corner of property								

MARIJUANA CULTIVATION FACILITY

1420 HATHAWAY DR.

CITY OF OWOSSO, SHIAWASSEE COUNTY, MICHIGAN SITE PLANS

ARCHITECT

MCI DESIGN GROUP 25280 RYAN ROAD WARREN, MI 48091

PHONE: (248) 390-2243

STANDARD LEGEND						
DESCRIPTION	PROPOSED					
BUILDING						
STORM SEWER	12 "					
SANITARY SEWER	s					
WATER	w					
GAS LINE	G					
ELECTRIC LINE	Е					
TELEPHONE LINE	т					
MANHOLE	•					
CATCH BASIN	→ □					
ENDSECTION						
FIRE HYDRANT	₩					
GATE VALVE & WELL	•					
UTILITY POLE	•					
UTILITY RISER						
LIGHT POLE	•					
CURB & GUTTER						
FENCE	xxx					
SILT FENCE						
TREE - DECIDUOUS	AS NOTED ON PLANS					
TREE LINE	~~~					
SPOT ELEVATION	+100.00					
CONTOUR LINE						
SECTION CORNER						
FOUND PROPERTY IRON						
SET PROPERTY IRON						
GAS METER						
ELECTRICAL METER						
TELEPHONE RISER						
MAILBOX						
SOIL BORING LOCATION						



THE LOCATION OF ALL UNDERGROUND UTILITIES AS SHOWN ON THESE DRAWINGS ARE BASED ON RECORDS PROVIDED BY THE UTILITY OWNERS AND VISIBLE EVIDENCE OBTAINED IN THE FIELD. NO GUARANTEE IS EITHER EXPRESSED OR IMPLIED TO THE COMPLETENESS OR ACCURACY THEREOF.



DRAWING INDEX

C1.0	COVER SHEET
C1.1	SITE DETAILS
C2.0	SURVEY PLAN
C3.0	SITE LAYOUT AND PAVING PLAN
C3.1	SITE LIGHTING AND LANDSCAPE PLAN
C4.0	GRADING AND UTILITY PLAN

BUILDING PLANS BY MCI DESIGN GROUP

A.100	PRE-ENGINEERED BUILDING REFERENCE DRAWINGS
/ \. OO	

A.101 PROPOSED FLOOR PLAN
A.102 EXTERIOR ELEVATIONS

CIVIL ENGINEER

AVANTI DEVELOPMENT GROUP, LLC 330 ENTERPRISE CT. BLOOMFIELD HILLS, MI 48302

PHONE: (810) 444-7815

FLOODPLAIN INFORMATION

CITY OF OWOSSO
SHIAWASSEE COUNTY, MICHIGAN
MAP NUMBER: 26155C0139C
EFFECTIVE DATE: 09/29/2011
FLOOD ZONE: AREA OF MINIMAL FLOOD HAZARD (FIRM MAP)

ZONING INFORMATION

ZONED- CC (COMMERCIAL COMMUNITY) SETBACKS-FRONT: - 75' REAR: -30'

SIDE: - 30' TOTAL OF 60

BENCHMARKS

BM =1 - ARROW ON HYDRANT LOCATED NEAR ENTRANCE TO 1420 HATHAWAY DRIVE

ELEV. 749.38 NAVD 88

SURVEYOR NOTES

- HORIZONTAL DATUM MICHIGAN STATE PLANE, MI SOUTH ZONE, NAD 83. VERTICAL DATUM NAVD 88 VERTICAL DATUM GPS DERIVED.

 SITE BENCHMARK ARROW ON TOP OF HYDRANT AT
- DRIVE ENTRANCE FOR 1410 HATHAWAY DRIVE. ELEVATION = 749.38'
 THE PROPERTY LINES SHOWN HEREON ARE NOT THE
- RESULT OF A BOUNDARY SURVEY BUT ARE REFERENCED FROM LANDMARK SURVEYING BOUNDARY JOB NO. 26763
 4. NO TITLE COMMITMENT WAS PROVIDED FOR THIS SURVEY SO THE LOCATION OF AN EASEMENTS ENCUMBERING THE PROPERTY ARE UNKNOWN.
- 5. THIS SITE WAS NOT FLAGGED BY MISS DIG AS OF THE DATE OF THE FIELD SURVEY, ANY UTILITIES PLOTTED HEREON WERE TAKEN FROM UTILITY PLANS PROVIDED BY THE CITY OF OWOSSO AND OBSERVED EVIDENCE. MISS DIG MUST BE CALLED FOR UTILITY LOCATING PRIOR TO EXCAVATION.

UTILITY NOTE

THE UTILITY LOCATIONS AS HEREON SHOWN ARE BASED ON FIELD OBSERVATIONS AND A CAREFUL REVIEW OF MUNICIPAL AND UTILITY RECORDS. HOWEVER, IT IS NOT POSSIBLE TO DETERMINE THE PRECISE SIZE, LOCATION, DEPTH, PRESSURE, OR ANY OTHER CHARACTERISTICS OF UNDERGROUND UTILITIES, TANKS OR SEPTIC FIELDS WITHOUT EXCAVATION. THEREFORE, WE CANNOT GUARANTEE THE ACCURACY OF COMPLETENESS OF THE BURIED UTILITY INFORMATION HEREON SHOWN. THE CONTRACTOR SHALL CALL MISS DIGG (1-800-482-7171) A MINIMUM OF THREE WORKING DAYS PRIOR TO ANY EXCAVATION. IT SHALL BE THE RESPONSIBILITY OF THE CONTRACTOR TO VERIFY THESE UTILITY LOCATIONS PRIOR TO CONSTRUCTION AND MAKE EVERY EFFORT TO PROTECT AND/OR RELOCATE THEM AS REQUIRED. THE CONTRACTOR SHALL NOTIFY THE ENGINEER/SURVEYOR AS SOON AS

POSSIBLE IN THE EVENT A DISCREPANCY IS FOUND.

FURNISHED DESCRIPTION

Part of the Southeast 1/4 of Section 14, T7N, R2E, Owosso Township, Shiawassee County, Michigan, described as beginning at a point that is \$90°00'00"W on the East and West 1/4 lift of said Section 14 a distance of 1866.23 feet and \$42°07'00 on the South Westerly right—of—way line of Grand Trunk Western Railroad a distance of 1201.61 feet from the East 1 corner of said Section 14; thence continuing \$42°07'00"E on said South Westerly railroad right—of—way line a distance of 602.94 feet (recorded as 604.14 feet); thence N89°59'25"W the East and West 1/8 line in the Southeast 1/4 of said Section 14 a distance of 7.99 feet; thence on a curve to the left having a radius of 305.00 feet, a central angle of 36°33'26" and a chord bearing and distance of N71°42'20"W 191.31 feet; thence N89°59'00"W 50.49 feet; thence N42°05'12"W 397.28 feet; thence N47°52'47"E 137.58 feet to the point of beginning, containing 1.51 acres, more or less. Subject to all easements and restrictions of record.

rcel R

Part of the Southeast 1/4 of Section 14, T7N, R2E, Owosso Township, Shiawassee County, Michigan, described as beginning at a point that is S90°00'00"W on the East and West 1/4 line of said Section 14 a distance of 1866.23 feet and S42°07'00"E on the South Westerly right—of—way line of Grand Trunk Western Railroad a distance of 1201.61 feet and S47°52'47"W 137.58 feet from the East 1/4 corner of said Section 14; thence S42°05'12"E 397.28 fet; thence N89°59'00"W 103.56; thence on a curve to the right having a radius of 245.00 feet, a central angle of 47°51'54" and a chord bearing and distance of N66°03'01"W 198.77 feet; thence N42°07'07"W 146.16 feet; thence N47°52'47"E 157.70 feet to the point of beginning, containing 1.14 acres, more or less. Subject to all easements and restrictions of use or record.

UTILITY CONTACTS

TELEPHONE
AT&T
c/o ENGINEERING DEPARTMENT
ROOM 525A
309 S. WASHINGTON AVE.
SAGINAW, MICHIGAN 48607
(989) 776-4070

GAS AND ELECTRIC
CONSUMERS ENERGY
2400 WEISS STREET
SAGINAW, MICHIGAN 48602
(989) 791-5903

ZONING


CITY OF OWOSSO
ZONING & PLANNING
301 W. MAIN STREET
OWOSSO, MICHIGAN 48867
(989) 725-0599

WATER/SEWER
CITY OF OWOSSO
WATER AND SEWER SERVICES
301 W. MAIN STREET
OWOSSO, MICHIGAN 48867
(989) 725-0550

ADG

Avanti Developme Group, LLC


> 330 Enterprise Ct. Bloomfield Hills, MI 48302 (PH) 810.444.7815

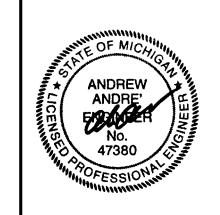

PREPARED UNDER THE DIRECTION OF ANDREW ANDRE, P.E.

APPLICANT: ALEXANDER CLOS


RIJUANA CULTIVAT
CILITY
0 HATHAWAY DR.

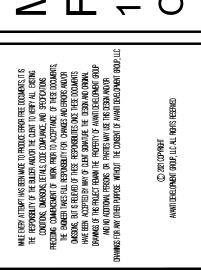

ISSUED FOR

DATE:
DRAWN: ACA
CHECKED: ACA
SCALE: NO SCALE
JOB NO: 2021-139
SHEET TITLE:
COVER SHEET
SHEET


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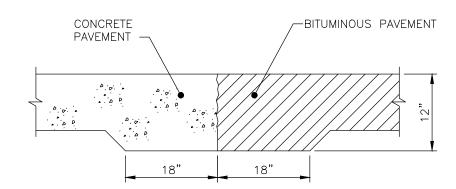
NOTE: A GEOTECHNICAL REPORT WITH PAVEMENT DESIGN RECOMMENDATIONS WAS NOT AVAILABLE, THEREFORE THE PAVEMENT SECTION REPRESENTS THE MINIMUM STANDARDS

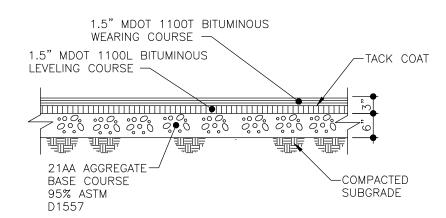BITUMINOUS PAVEMENT


NO SCALE




CONCRETE PAVEMENT

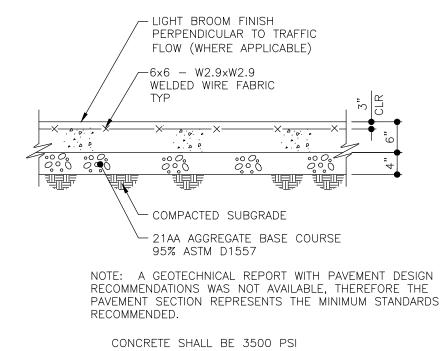


TURNDOWN PAVEMENT SECTION NO SCALE

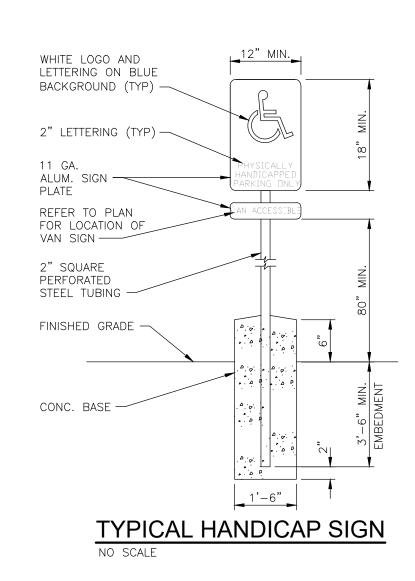


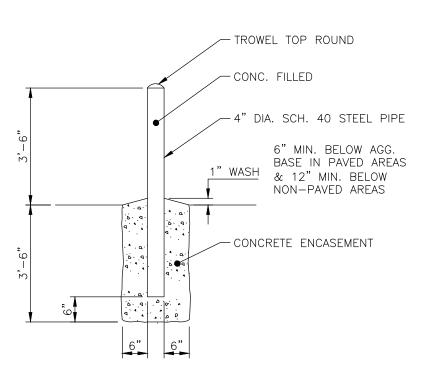

BOLLARD NO SCALE

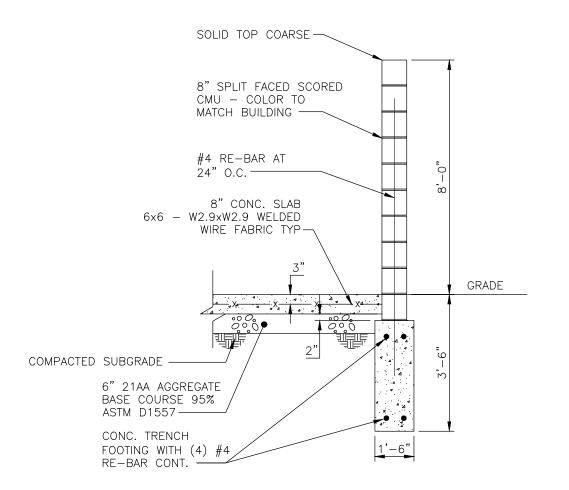

DUMPSTER WALL
NO SCALE

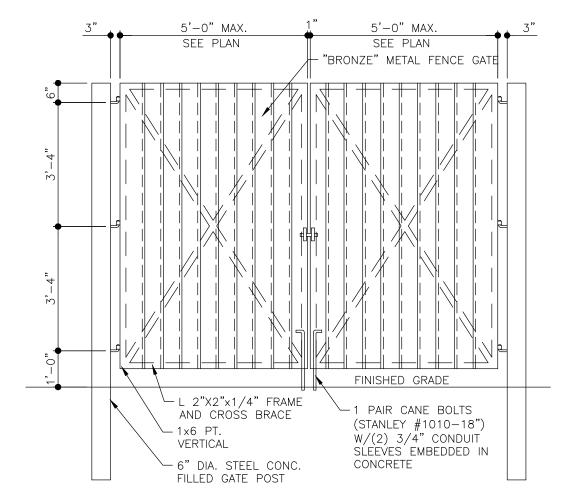

DUMPSTER GATE DETAIL



Avanti Development Group, LLC

330 Enterprise Ct. Bloomfield Hills, MI 48302 (PH) 810.444.7815





PREPARED UNDER THE DIRECTION OF: ANDREW ANDRE, P.E. MI #47380

APPLICANT: ALEXANDER CLOSE

TIVATIO COL **RIJUANA**

88	
ISSUED FOR	DATE
SPA/SLU	11/24/21
DATE :	
DRAWN: ACA	
CHECKED: ACA	
SCALE: NO SCALE	
JOB NO: 2021-139	
SHEET TITLE :	
SITE DETAILS	

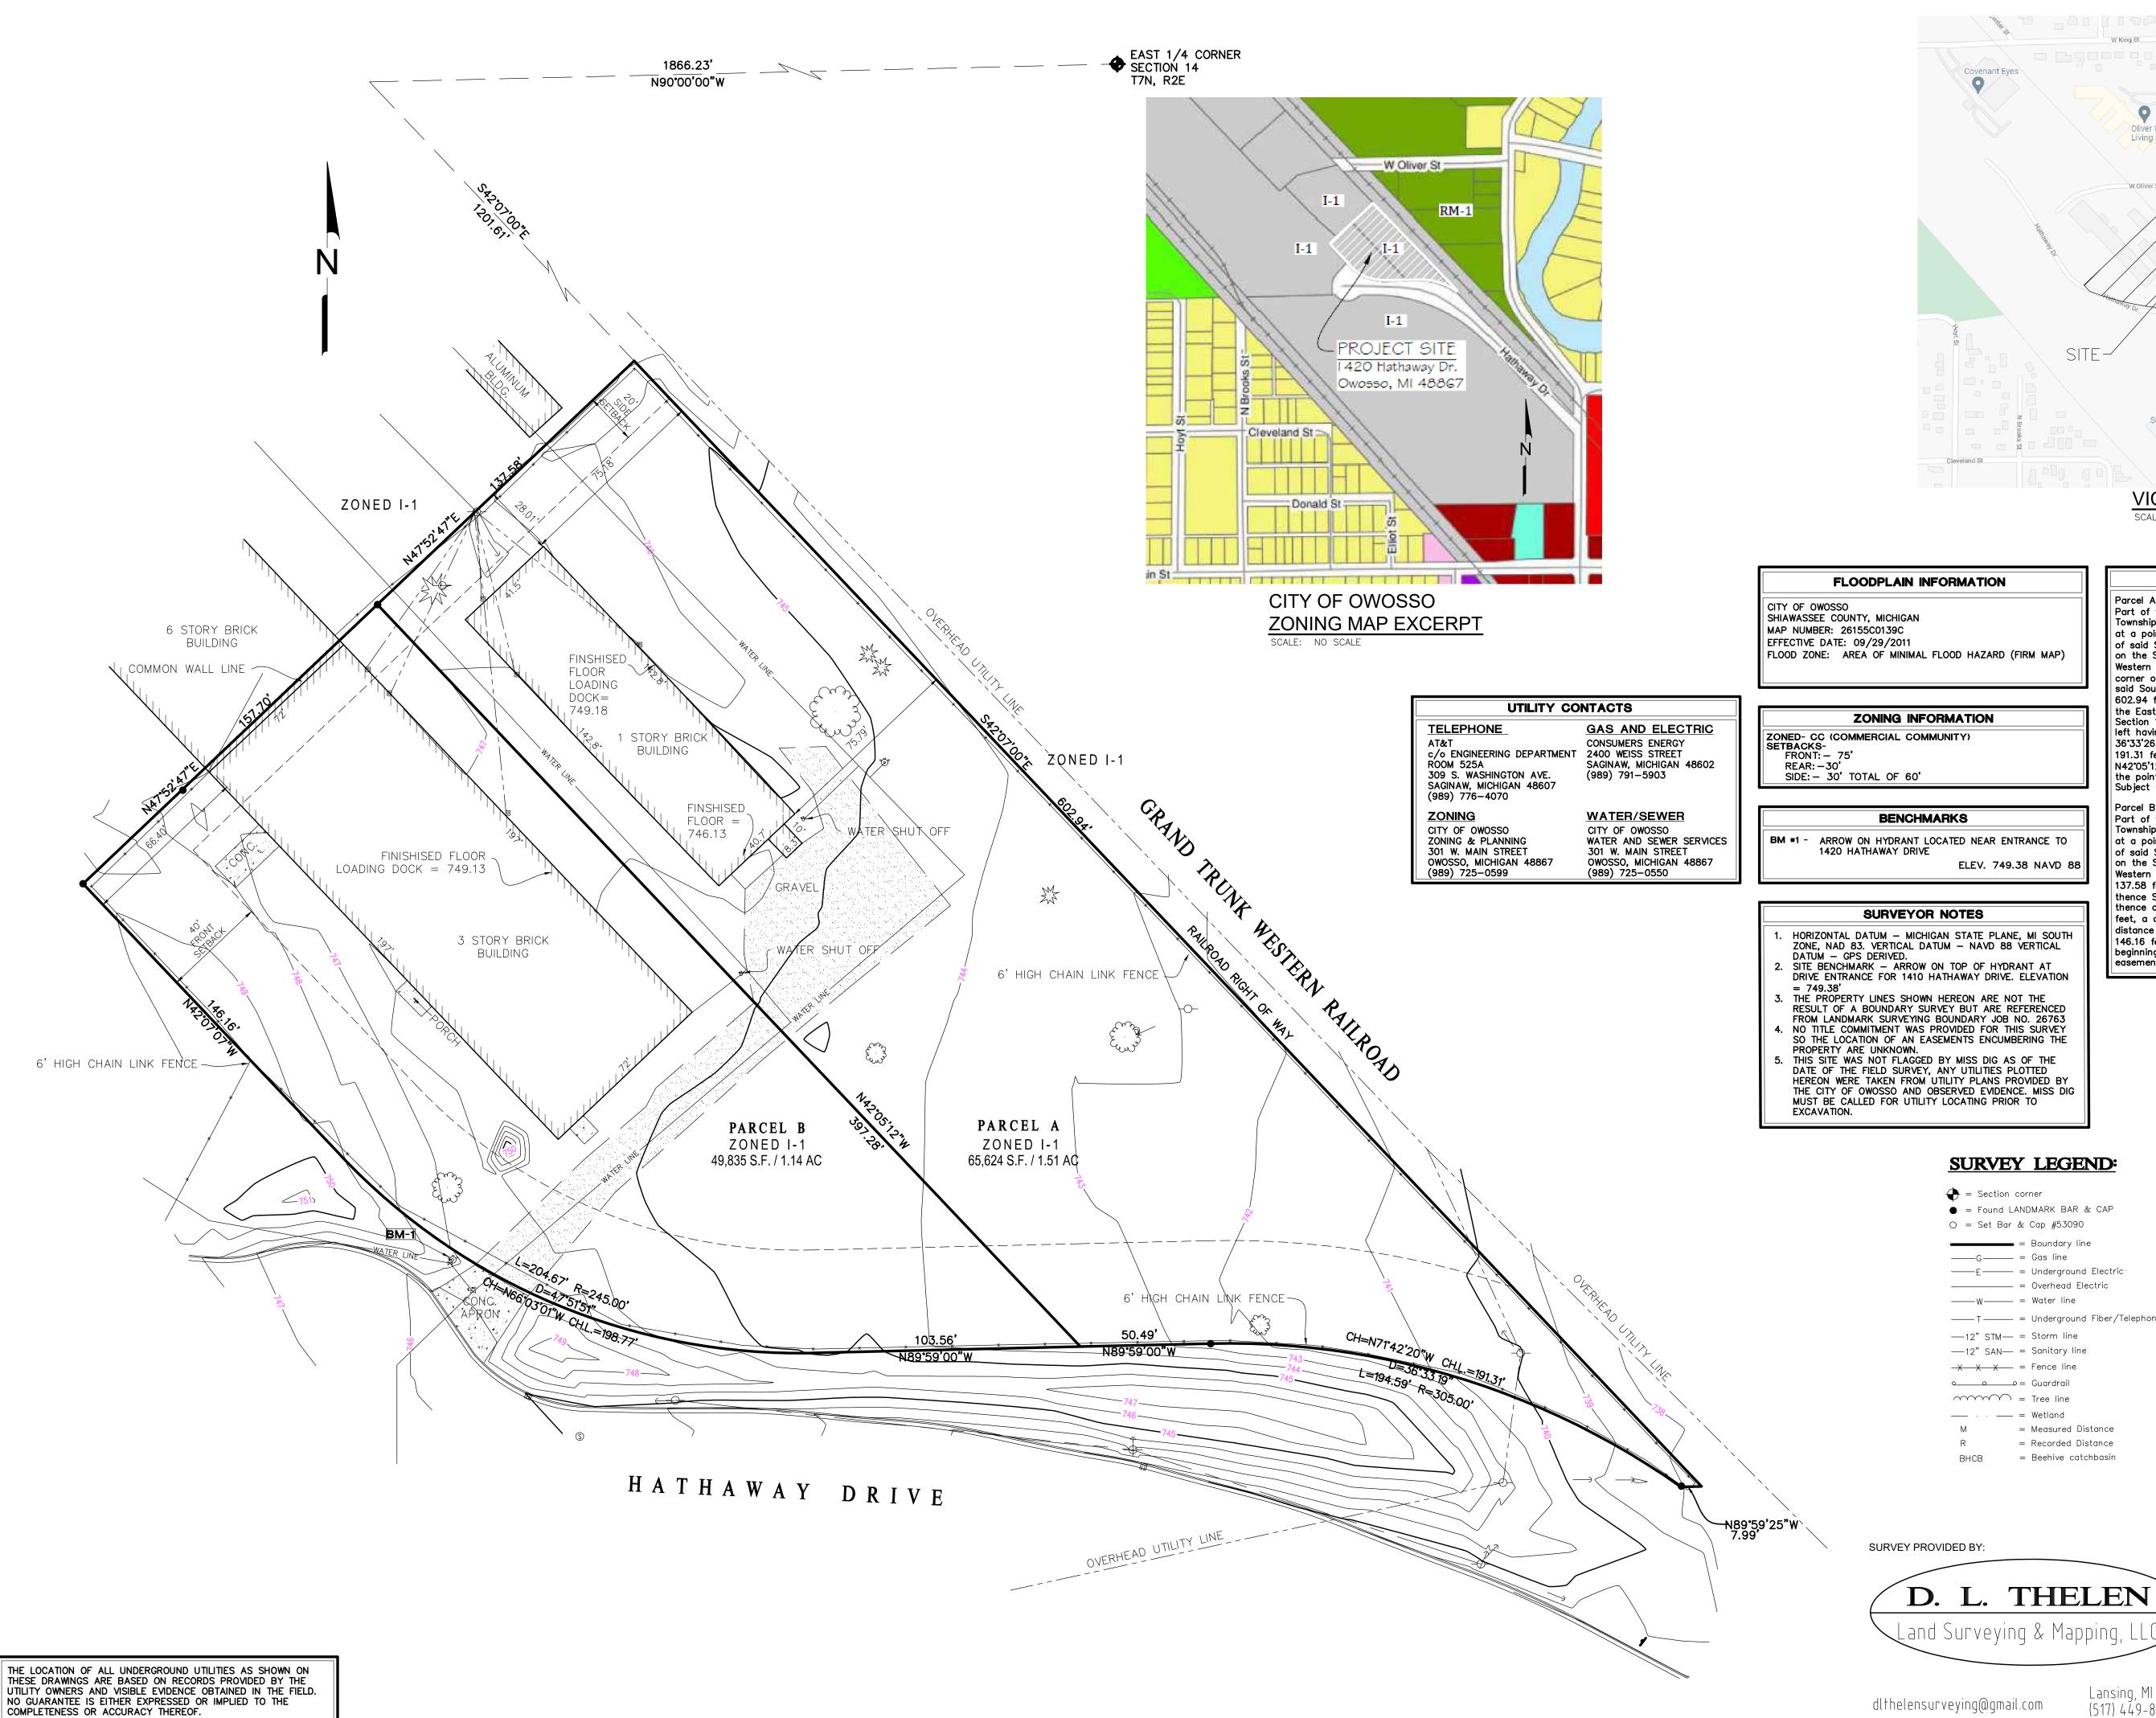

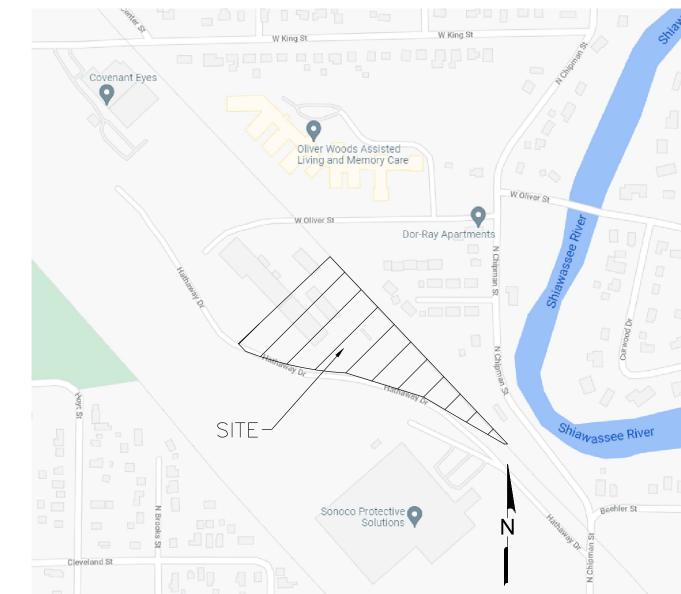

VICINITY MAP

FLOOD ZONE: AREA OF MINIMAL FLOOD HAZARD (FIRM MAP)

ZONING INFORMATION

BM #1 - ARROW ON HYDRANT LOCATED NEAR ENTRANCE TO

ELEV. 749.38 NAVD 88

SURVEYOR NOTES

- SITE BENCHMARK ARROW ON TOP OF HYDRANT AT DRIVE ENTRANCE FOR 1410 HATHAWAY DRIVE. ELEVATION
- . THE PROPERTY LINES SHOWN HEREON ARE NOT THE RESULT OF A BOUNDARY SURVEY BUT ARE REFERENCED FROM LANDMARK SURVEYING BOUNDARY JOB NO. 26763 NO TITLE COMMITMENT WAS PROVIDED FOR THIS SURVEY
- THIS SITE WAS NOT FLAGGED BY MISS DIG AS OF THE DATE OF THE FIELD SURVEY, ANY UTILITIES PLOTTED HEREON WERE TAKEN FROM UTILITY PLANS PROVIDED BY THE CITY OF OWOSSO AND OBSERVED EVIDENCE. MISS DIG MUST BE CALLED FOR UTILITY LOCATING PRIOR TO

FURNISHED DESCRIPTION

Part of the Southeast 1/4 of Section 14, T7N, R2E, Owosso Township, Shiawassee County, Michigan, described as beginning at a point that is S90°00'00"W on the East and West 1/4 line of said Section 14 a distance of 1866.23 feet and S42°07'00"E on the South Westerly right—of—way line of Grand Trunk
Western Railroad a distance of 1201.61 feet from the East 1/4 corner of said Section 14; thence continuing S42°07'00"E on said South Westerly railroad right-of-way line a distance of 602.94 feet (recorded as 604.14 feet); thence N89°59'25"W or the East and West 1/8 line in the Southeast 1/4 of said Section 14 a distance of 7.99 feet; thence on a curve to the left having a radius of 305.00 feet, a central angle of 36°33'26" and a chord bearing and distance of N71°42'20"W 191.31 feet; thence N89°59'00"W 50.49 feet; thence N42°05'12"W 397.28 feet; thence N47°52'47"E 137.58 feet to the point of beginning, containing 1.51 acres, more or less. Subject to all easements and restrictions of record.

Part of the Southeast 1/4 of Section 14, T7N, R2E, Owosso Township, Shiawassee County, Michigan, described as beginning at a point that is \$90°00'00"W on the East and West 1/4 line of said Section 14 a distance of 1866.23 feet and S42'07'00"E on the South Westerly right—of—way line of Grand Trunk Western Railroad a distance of 1201.61 feet and S47*52'47"W 137.58 feet from the East 1/4 corner of said Section 14; thence S42°05'12"E 397.28 fet: thence N89°59'00"W 103.56: thence on a curve to the right having a radius of 245.00 feet, a central angle of 47°51'54" and a chord bearing and distance of N66°03'01"W 198.77 feet; thence N42°07'07"W 146.16 feet; thence N47°52'47"E 157.70 feet to the point of beginning, containing 1.14 acres, more or less. Subject to all easements and restrictions of use or record.

SURVEY LEGEND:

= Section corner ● = Found LANDMARK BAR & CAP

= Boundary line ____G___ = Gas line ———E——— = Underground Electric _____ = Overhead Electric _____w___ = Water line

T = Underground Fiber/Telephone -12" STM- = Storm line --12" SAN-- = Sanitary line X X X = Fence line

= Beehive catchbasin

(517) 449-8330

= Tree line = Measured Distance = Recorded Distance FTCB = Flattop catchbasin = Benchmark

 Storm Manhole = Flattop Catchbasin S = Sanitary Manhole) = Sanitary Cleanout 🍪 = Hydrant

₩ = Gas Valve

💽 = Gas Meter

 $\frac{}{}$ = Sign

= Mailbox

= Soil Boring

₩V ⋈ = Water Valve (T) = Telephone Manhole ₩© = Water Shut Off 🗉 = Telephone Pedestal W = Water Manhole AC Unit W = Well

Post (MW) = Monitoring Well E 3 = Deciduous Tree

Electric Meter

= Transformer

-O-= Utility Pole

-**()** = Guy Pole

 \longrightarrow = Guy Wire

E = Electric Manhole

Coniferous Tree = Shrub/Bush

Know what's below. Call before you dig.

30' 60' SCALE: 1" = 30'

Avanti Developmen Group, LLC

330 Enterprise Ct. Bloomfield Hills, MI 48302 (PH) 810.444.7815

PREPARED UNDER THE DIRECTION OF: ANDREW ANDRE, P.E.

APPLICANT:


ALEXANDER CLOSE

DR 20 HATHAWAY DR 70SSO, MI 48867 MA FA(142(OW(


ISSUED FOR

SPA/SLU

DATE: DRAWN: ACA CHECKED: ACA SCALE: 1"=30' JOB NO: 2021-139 SHEET TITLE: SURVEY PLAN

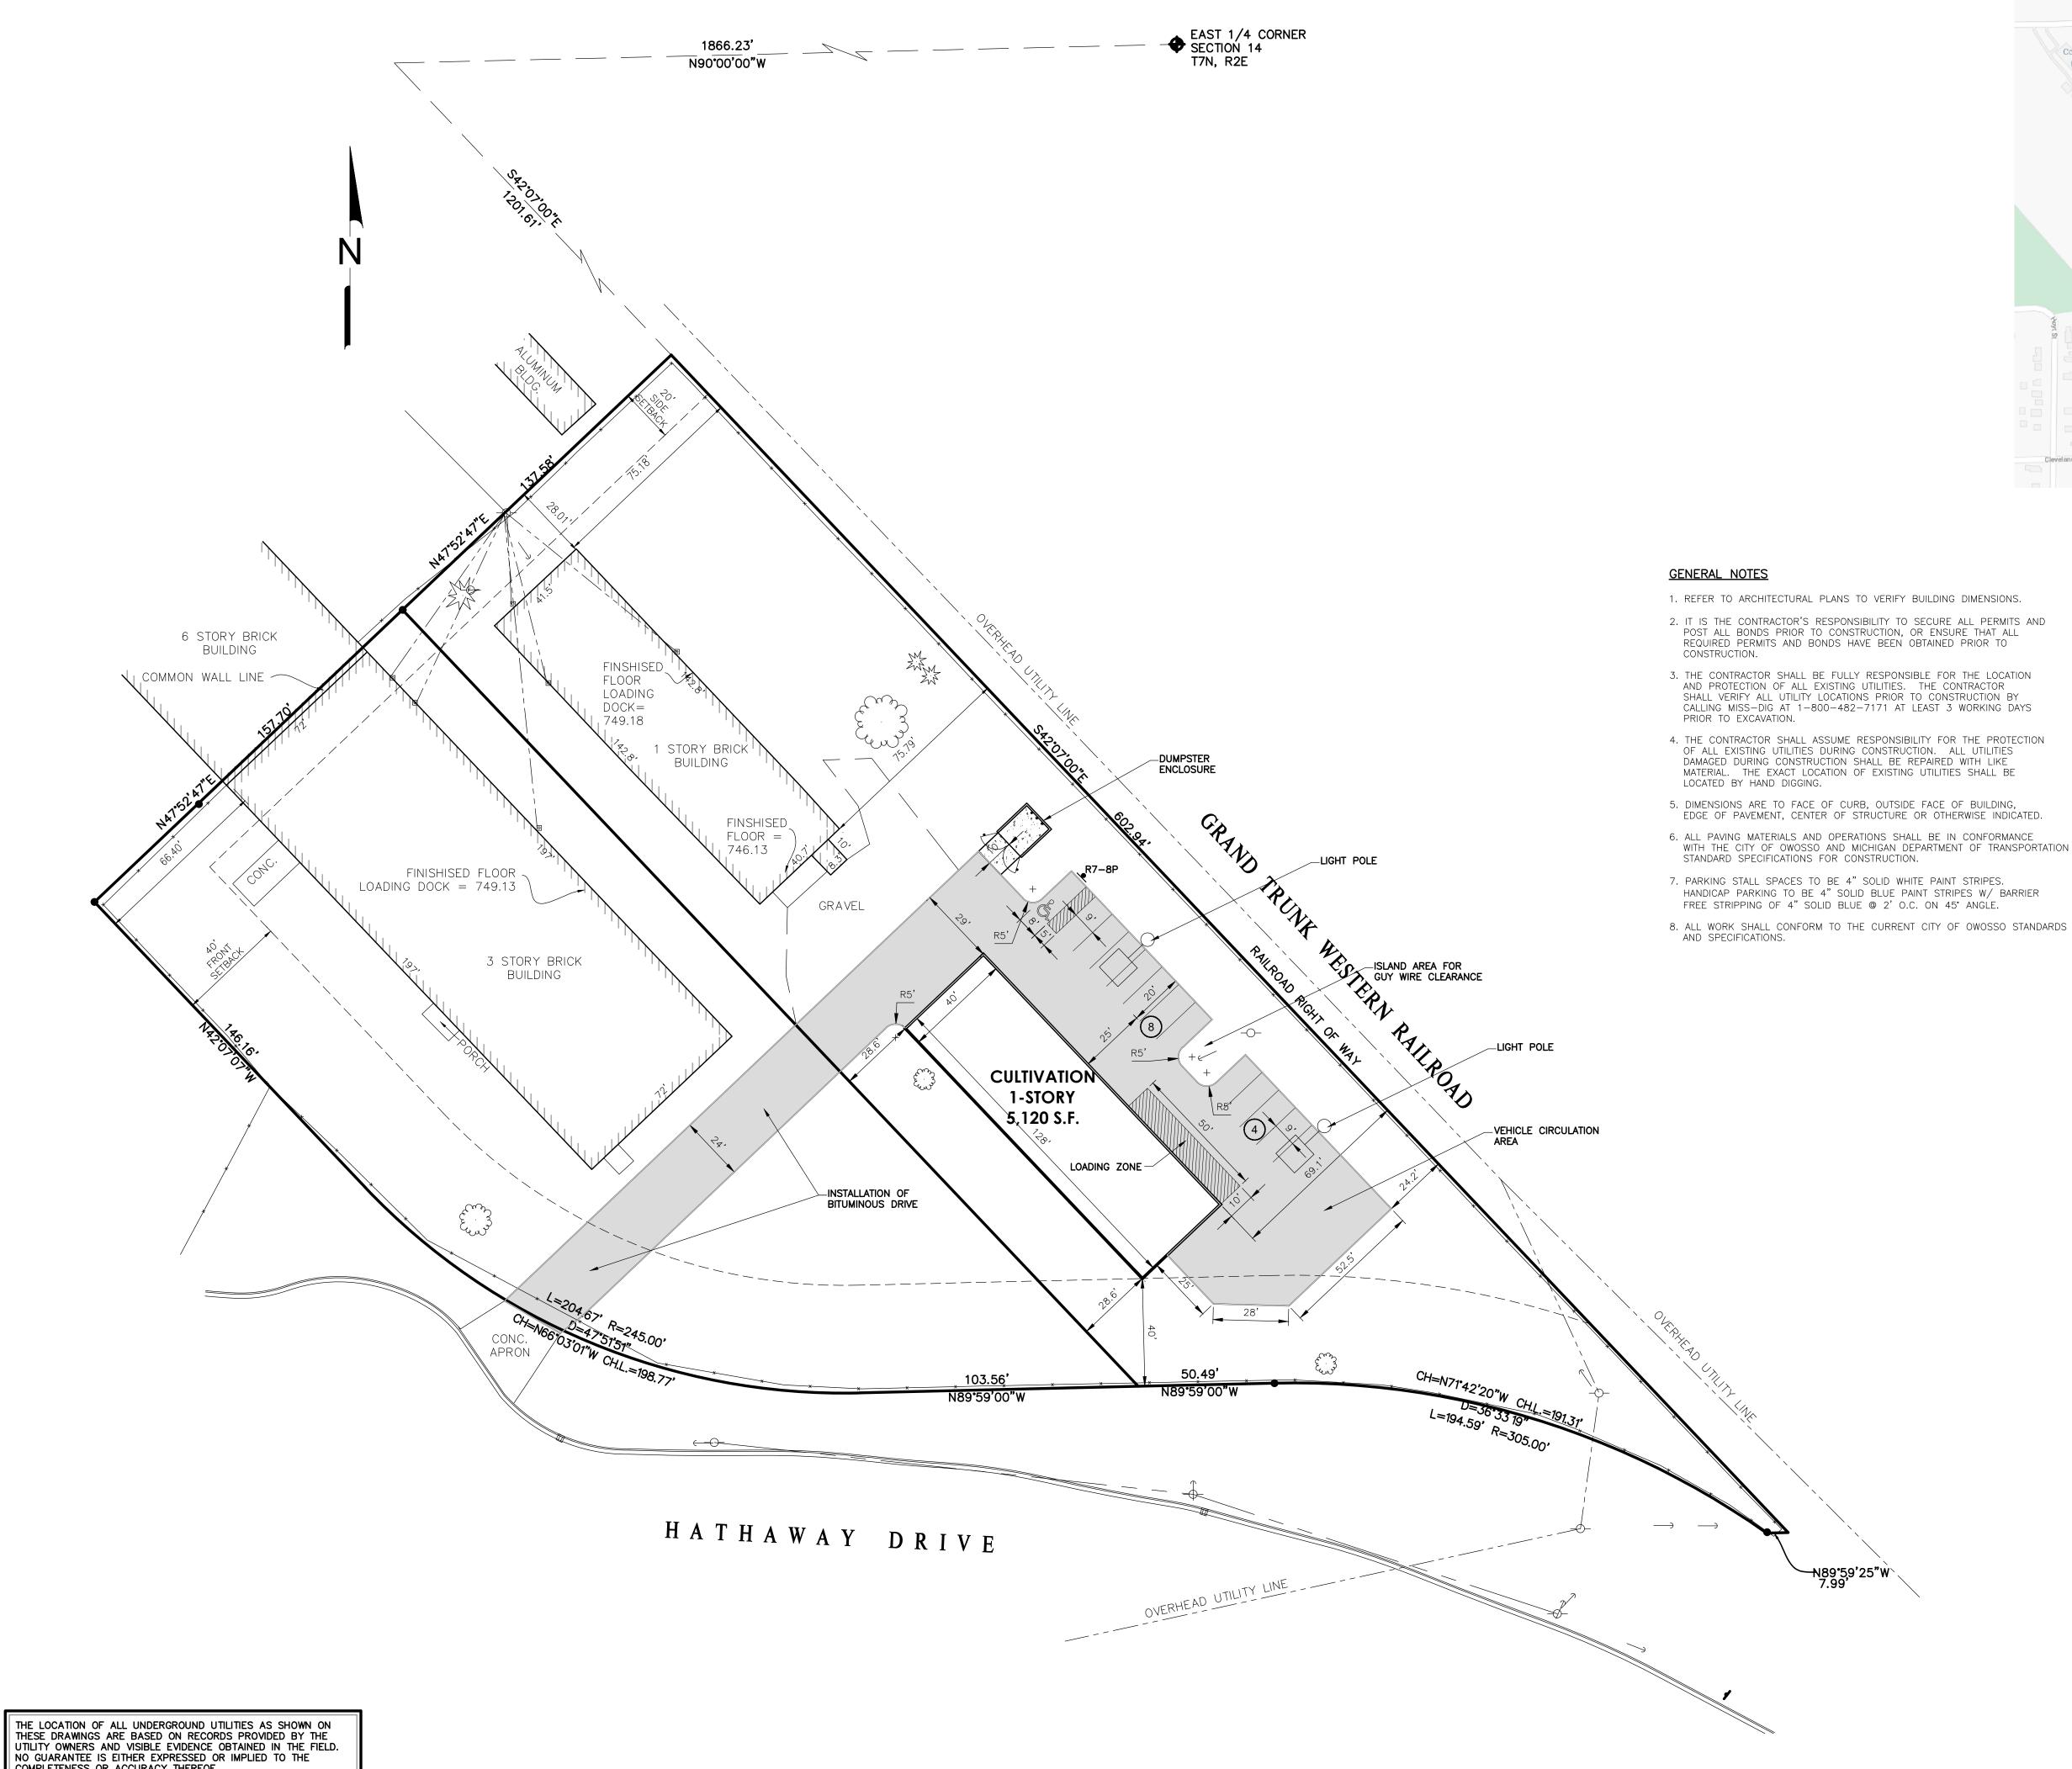

COMPLETENESS OR ACCURACY THEREOF.

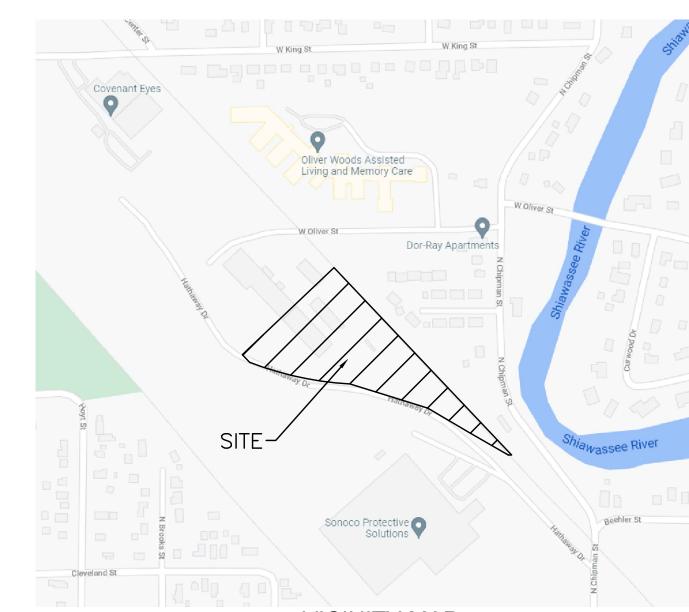

VICINITY MAP SCALE: NO SCALE

- 2. IT IS THE CONTRACTOR'S RESPONSIBILITY TO SECURE ALL PERMITS AND POST ALL BONDS PRIOR TO CONSTRUCTION, OR ENSURE THAT ALL REQUIRED PERMITS AND BONDS HAVE BEEN OBTAINED PRIOR TO
- 3. THE CONTRACTOR SHALL BE FULLY RESPONSIBLE FOR THE LOCATION AND PROTECTION OF ALL EXISTING UTILITIES. THE CONTRACTOR SHALL VERIFY ALL UTILITY LOCATIONS PRIOR TO CONSTRUCTION BY CALLING MISS—DIG AT 1—800—482—7171 AT LEAST 3 WORKING DAYS
- OF ALL EXISTING UTILITIES DURING CONSTRUCTION. ALL UTILITIES DAMAGED DURING CONSTRUCTION SHALL BE REPAIRED WITH LIKE MATERIAL. THE EXACT LOCATION OF EXISTING UTILITIES SHALL BE
- 5. DIMENSIONS ARE TO FACE OF CURB, OUTSIDE FACE OF BUILDING,
- 6. ALL PAVING MATERIALS AND OPERATIONS SHALL BE IN CONFORMANCE WITH THE CITY OF OWOSSO AND MICHIGAN DEPARTMENT OF TRANSPORTATION
- 7. PARKING STALL SPACES TO BE 4" SOLID WHITE PAINT STRIPES. HANDICAP PARKING TO BE 4" SOLID BLUE PAINT STRIPES W/ BARRIER

SITE INFORMATION

I-1 (LIGHT INDUSTRIAL)

PROPOSED LAND USE IS MARIJUANA CULTIVATION

PARKING DATA: REQUIRED

- A MINIMUM OF FIVE (5), PLUS ONE (1) FOR EACH 1.2 OFFICE EMPLOYEES AND ONE (1) FOR EACH 2.3 FACTORY EMPLOYEES IN THE LARGEST WORKING SHIFT <OR> ONE (1) FOR EVERY FIVE HUNDRED FIFTY (550) SQUARE FEET OF USABLE FLOOR SPACE, OR WHICHEVER IS DÉTERMINED TO THE THE GREATER.
- OCCUPANCY = 16 (PER MBC TABLE 1004.1.2) EMPLOYEES = 16 (2 OFFICE, 14 FACTORY) REQUIRED = 5 + 2 + (14/2.3) = 11 SPACES
- USABLE FLOOR SPACE = 4,730 S.F.
- REQUIRED = 4,730 / 550 = 9 SPACES

REQUIRED = 11 SPACES

STANDARD SPACES = 11 ADA SPACES = 1 (INCLUDING 1 VAN ACCESSIBLE) TOTAL PROVIDED = 12 SPACES

PAVEMENT INFORMATION

BITUMINOUS PAVEMENT CONCRETE PAVEMENT

TRAFFIC CONTROL	SIGN TABLE
DESCRIPTION	MMUTCD
HANDICAP (VAN)	R7-8P


ALL TRAFFIC SIGNAGE SHALL COMPLY WITH THE CURRENT MMUTCD STANDARDS



SCALE: 1" = 30

Avanti Developmen Group, LLC

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APPLICANT:
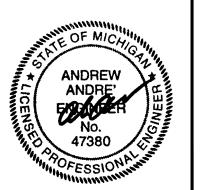
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IAWAY DR. MI 48867 Ξ


11/24/21

ISSUED FOR

SPA/SLU

DATE: DRAWN: ACA CHECKED: ACA SCALE: 1"=30' JOB NO: 2021-139 SHEET TITLE : SITE LAYOUT AND PAVING PLAN SHEET

C3.0

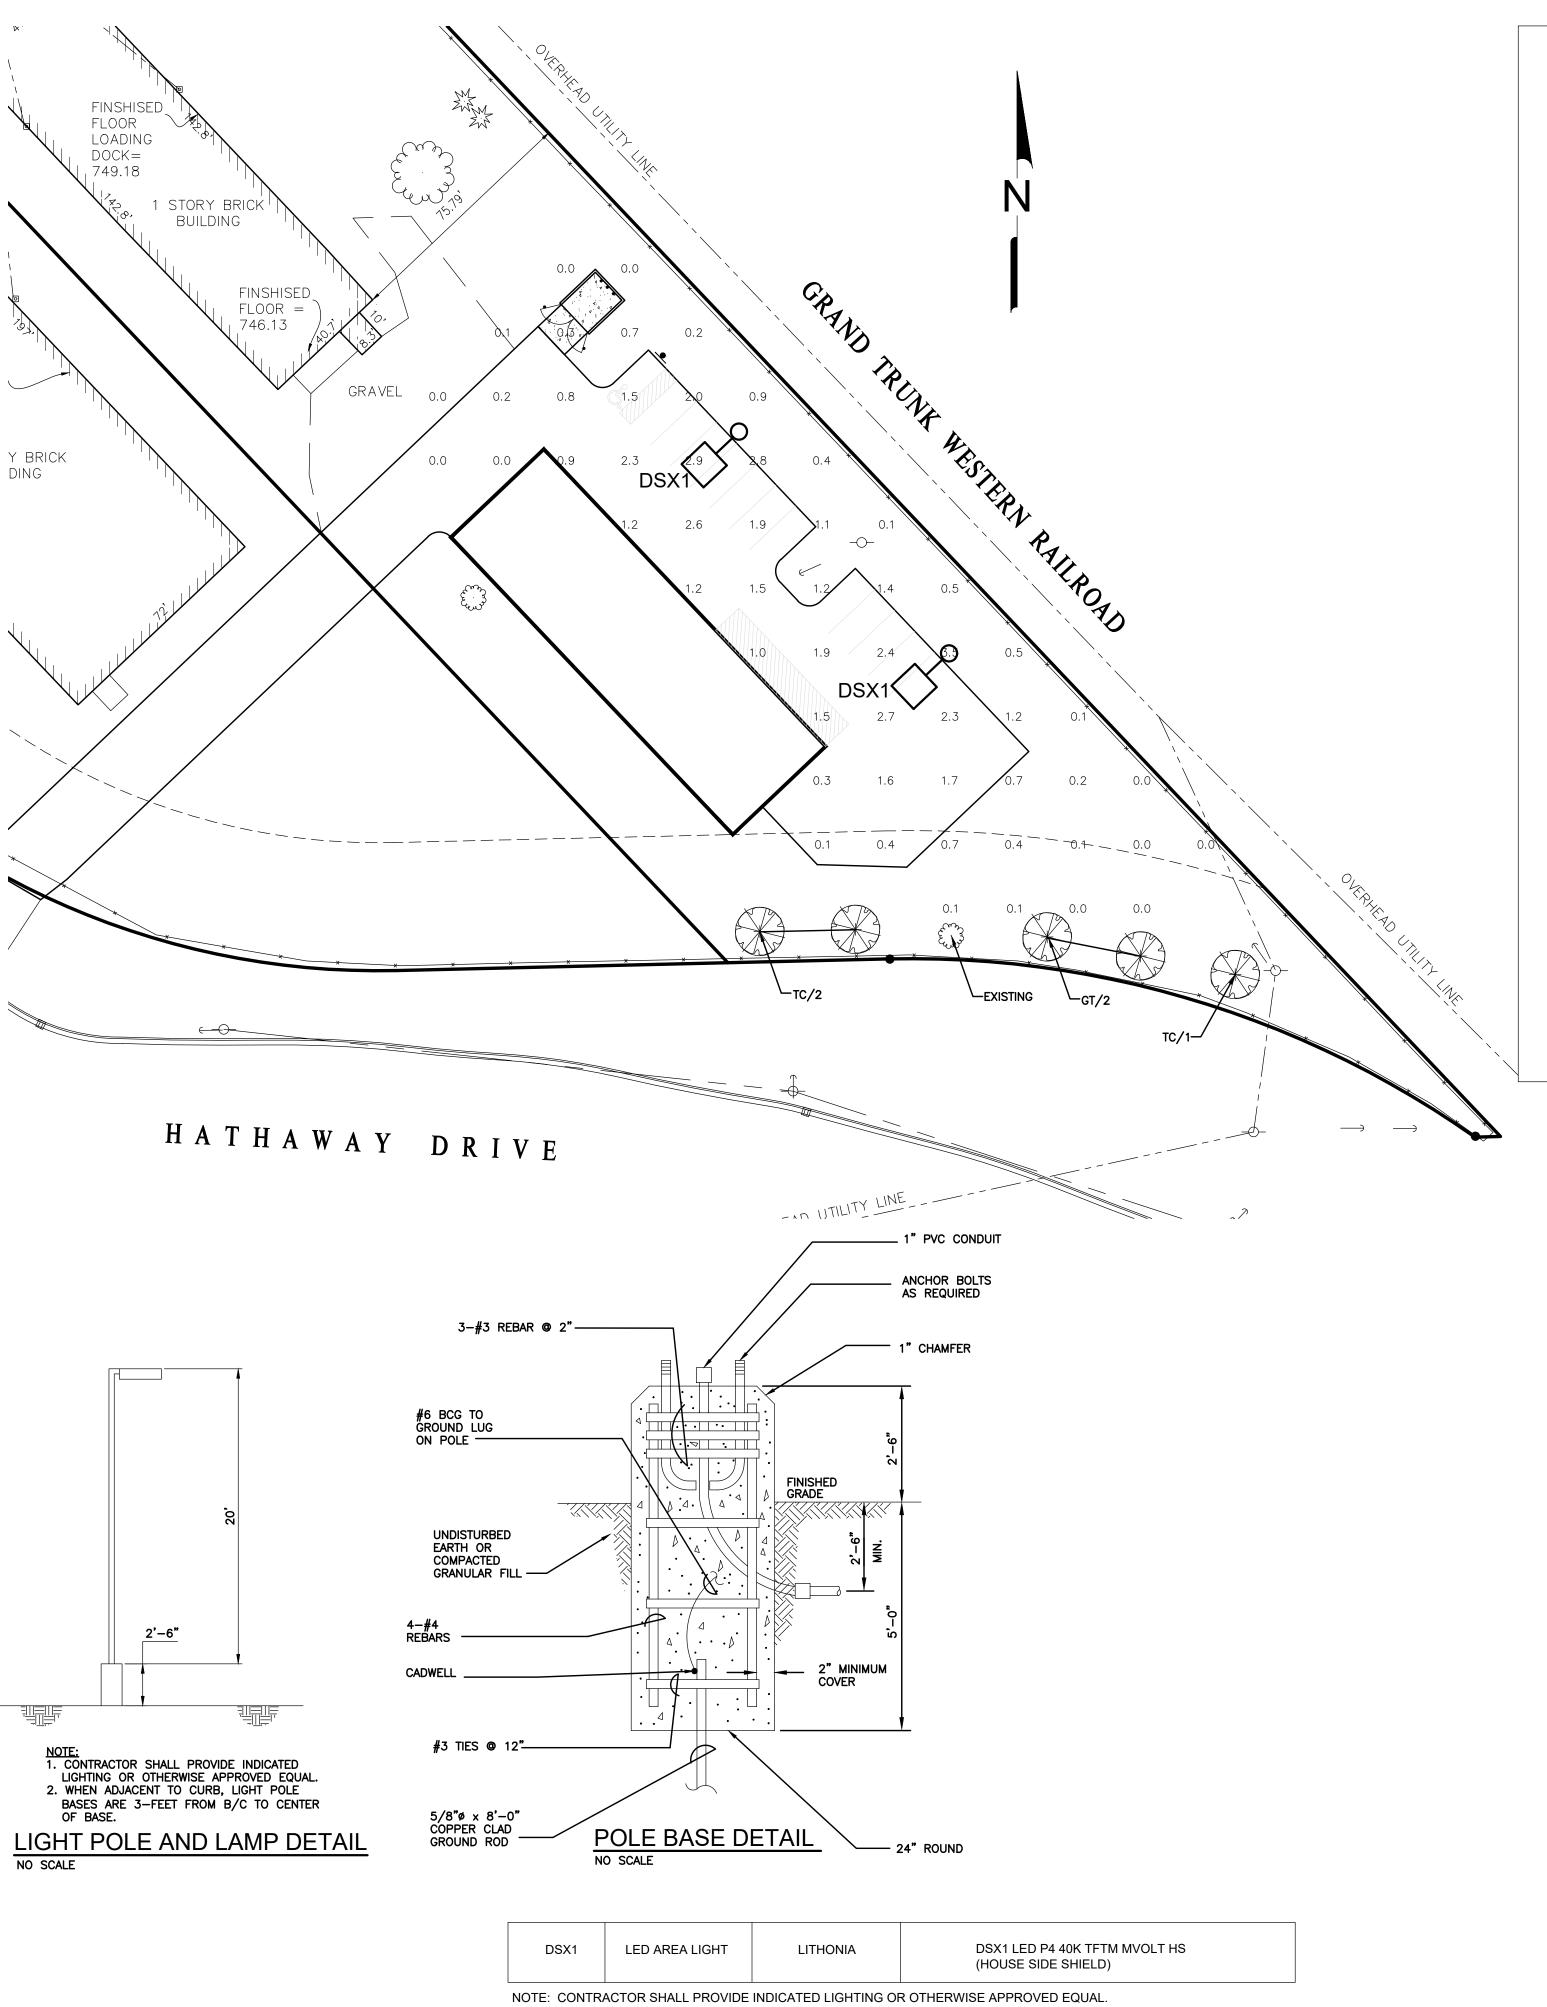

AVERAGE	MAXIMUM	MINIMUM		
0.9 FC	3.5 FC	0.0 FC		

THE LOCATION OF ALL UNDERGROUND UTILITIES AS SHOWN ON THESE DRAWINGS ARE BASED ON RECORDS PROVIDED BY THE UTILITY OWNERS AND VISIBLE EVIDENCE OBTAINED IN THE FIELD.

NO GUARANTEE IS EITHER EXPRESSED OR IMPLIED TO THE

COMPLETENESS OR ACCURACY THEREOF.

D-Series Size 1 LED Area Luminaire Inghting facts

This item is an A+ capable luminaire, which has been

designed and tested to provide consistent color

Brands' specification for chromatic consistency

DTL® controls marked by a shaded background.

for ROAM® or XPoint™ Wireless control networks,

providing out-of-the-box control compatibility

with simple commissioning, when ordered with

Shipped separately

BS Bird spikes²²

drivers and control options marked by a shaded

DTL DLL equipped luminaires meet the A+

specification for luminaire to photocontrol

appearance and system-level interoperability.

4 Capable Luminaire

interoperability1

background¹


Specifications

A+ Capable options indicated by this color background.

DSX1LED

DSX1 LED

Ordering Information

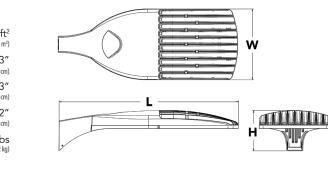

• All configurations of this luminaire meet the Acuity • This luminaire is A+ Certified when ordered with • This luminaire is part of an A+ Certified solution

To learn more about A+, visit www.acuitybrands.com/aplus. 1. See ordering tree for details. 2. A+ Certified Solutions for ROAM require the order of one ROAM node per luminaire. Sold

Separately: Link to Roam; Link to DTL DLL **EXAMPLE:** DSX1 LED P7 40K T3M MVOLT SPA DDBXD

s		Color ter	Color temperature		Distribution			Voltage				
	P4 P5 P6 Pd optics P12 ¹	P7 P8 P9	30K 40K 50K AMBPC	3000 K 4000 K 5000 K Amber phosphor converted ²	T1S T2S T2M T3S T3M T4M	Type I short Type II short Type II medium Type III short Type III short Type IV medium Type IV medium	T5S T5M T5W BLC LCCO	Type V short Type V medium Type V wide Backlight control ^{2,3} Left corner cutoff ^{2,3}	MVOLT 4,5 120 6 208 5,6 240 5,6 277 6 347 5,6,7	Shipped includ SPA RPA WBA SPUMBA RPUMBA	Square pole mounting Round pole mounting Wall bracket Square pole universal mounting adaptor ⁸ Round pole universal mounting adaptor ⁸	
l'	P13 ¹				TFTM T5VS	Forward throw medium Type V very short	RCCO	Right corner cutoff ^{2,3}	480 5,6,7	Shipped separa KMA8 DDBXD U	Ately Mast arm mounting bracket adaptor (specify finish) 9	

otions				options	Finish (required)	
Installed nLight AIR generation 2 enabled ¹⁰ NEMA twist-lock receptacle only (controls ordered separate) ¹¹ Five-wire receptacle only (controls ordered separate) ^{11,12} Seven-wire receptacle only (controls ordered separate) ^{11,12}	PIRH1FC3V BL30 BL50 PNMTDD3	Bi-level, motion/ambient sensor, 15–30' mounting height, ambient sensor enabled at 1fc. 51,51,6 Bi-level switched dimming, 30% 5,14,18 Bi-level switched dimming, 50% 5,14,18 Part night, dim till dawn 5,19	Shipp HS SF DF	House-side shield ²¹ Single fuse (120, 277, 347V) ⁶ Double fuse (208, 240, 2001, 6	DDBXD DBLXD DNAXD DWHXD DDBTXD	Dark bronze Black Natural aluminum White Textured dark bronze
0–10V dimming extend out back of honsing for external control (leads exit fixture) Dual switching ^{13,14}	PNMT5D3	Part night, dim 6 hrs ^{5,19}	L90	480V) ⁶ Left rotated optics ¹ Right rotated optics ¹	DBLBXD DNATXD	Textured black Textured natural

Bi-level, motion/ambient sensor, 8–15' mounting height, ambient sensor enabled at 5fc 5,15,16 PNMT7D3 Part night, dim 7 hrs 5,19 Bi-level, motion/ambient sensor, 15–30' mounting height, ambient sensor enabled at 5fc 5,15,16 FAO Field adjustable output²⁰ PIRHN Network, Bi-Level motion/ambient sensor¹⁷ **PIR1FC3V** Bi-level, motion/ambient sensor, 8–15' mounting height, ambient sensor enabled at 1fc^{5,15,16}

EGS External glare shield²² LITHONIA LIGHTING. One Lithonia Way • Conyers, Georgia 30012 • Phone: 800.279.8041 • www.lithonia.com © 2011-2018 Acuity Brands Lighting, Inc. All rights reserved.

GENERAL NOTES

ON-SITE.

1. LANDSCAPE CONTRACTOR TO PROVIDE DESIGN AND INSTALLATION OF UNDERGROUND IRRIGATION SYSTEM IN ACCORDANCE WITH PROJECT SPECIFICATIONS AND REGULATORY AGENCY REQUIREMENTS. ALL LANDSCAPING, PLANTING AND GRASS AREAS TO BE

2. ALL GREEN SPACES AND PLANTING AREAS SHALL BE IRRIGATED. LANDSCAPE CONTRACTOR SHALL PROVIDE IRRIGATION DESIGN.

3. IT IS THE CONTRACTOR'S RESPONSIBILITY TO SECURE ALL PERMITS AND POST ALL BONDS PRIOR TO CONSTRUCTION.


4. REFER TO PLUMBING PLANS FOR LOCATION OF IRRIGATION METER.

5. ALL GRASS/LAWN AREAS SHALL BE SOD OVER 4-INCHES OF TOPSOIL.

6. SPACE ALL SHRUBS AT 5-FEET ON CENTER UNLESS OTHERWISE INDICATED ON THE PLANS

7. ALL DISTURBED LAWN AREAS SHALL BE RESTORED TO AT LEAST PREVIOUS CONDITION IN ACCORDANCE WITH PROJECT SPECIFICATIONS.

8. THE GENERAL CONTRACTOR SHALL INCLUDE TOPSOIL IN BASE BID. NO GUARANTEE IS EITHER EXPRESSED OR IMPLIED AS TO THE AMOUNT OF TOPSOIL AVAILABLE

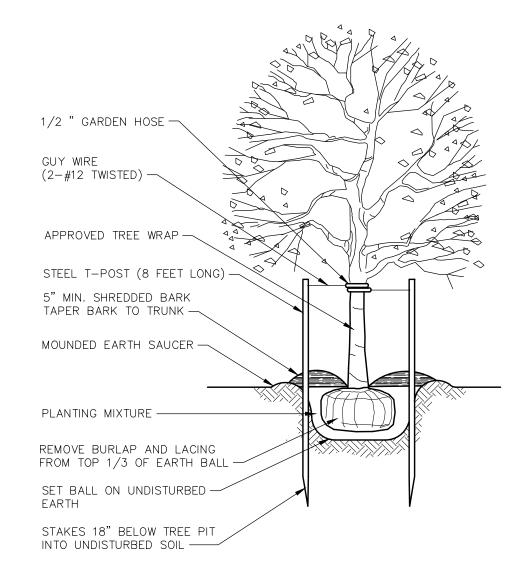

DWHGXD Textured white

DSX1-LED

Rev. 03/21/18

Page 1 of 7

DECIDUOUS TREE PLANTING

SCALE: NONE

PLANTING LIST

QUANTITY KEY BOTANICAL NAME			COMMON NAME	SIZE
DECIDUOUS TREES				
3	GT	GLEDITSIA T.I. 'SKYLINE'	SKYLINE HONEYLOCUST	2-1/2" B&B
3	TC	TILIA CORDATA 'GREENSPIRE'	GREENSPIRE LINDEN	2-1/2" B&B

LANDSCAPE NOTES

THIS WORK SHALL CONSIST OF PROVIDING ALL NECESSARY MATERIALS, LABOR, EQUIPMENT, TOOLS AND SUPERVISION REQUIRED FOR THE EXECUTION AND GUARANTEE OF ALL PLANTINGS AND RELATED WORK AS SHOWN ON THE DRAWINGS.

PLANT MATERIALS SHALL CONFORM TO THE SIZES STATED ON THE PLANT LIST AND SHALL BE OF A MINIMUM SIZE OR LARGER. ALL MEASUREMENTS OF SPREAD, CALIPER, BALL SIZE, TRUNK CROWN RATIO, QUALITY DESIGNATIONS, ETC., SHALL BE IN ACCORDANCE WITH THE LATEST EDITION OF THE "ANSI STANDARDS FOR NURSERY STOCK". PLANT MATERIAL SHALL BE NURSERY GROWN AND INSPECTED BY THE OWNER'S REPRESENTATIVE AT THE SITE PRIOR TO PLANTING. THE OWNER'S REPRESENTATIVE RESERVES THE RIGHT TO REJECT ANY PLANT MATERIAL AT ANY TIME.

NURSERY STOCK SHALL BE PREPARED FOR SHIPMENT IN ACCORDANCE WITH THE REQUIREMENTS OF THE CURRENT ANSI SPECIFICATION Z60.1 AND SHALL BE ENCLOSED OR COVERED DURING TRANSPORTATION TO PREVENT

SITE PREPARATION

THE CONTRACTOR SHALL VERIFY ALL EXISTING AND PROPOSED UTILITY LOCATIONS PRIOR TO CONSTRUCTION AND PROTECT AND REPAIR UTILITIES ENCOUNTERED DURING CONSTRUCTION WHETHER SHOWN ON THE PLANS OR

INDIVIDUAL HOLES SHALL BE CENTERED AT STAKED PLANT LOCATIONS. CONTRACTOR IS TO STAKE PRIOR TO PLACEMENT OF PLANT MATERIAL AND OBTAIN APPROVAL FROM THE OWNER'S REPRESENTATIVE. PLANTING HOLES SHALL BE DUG LARGE ENOUGH TO PERMIT PLACING PREPARED TOPSOIL 18" LATERALLY BEYOND THE ENDS OF THE ROOT BALLS FOR SHADE AND EVERGREEN TREES AND 6" LATERALLY FOR SHRUBS UNLESS OTHERWISE

EXCAVATED MATERIAL SHALL BE REMOVED FROM THE SITE AT THE TIME THE HOLE IS DUG. THE PLANTING HOLE SHALL BE BACKFILLED WITH PREPARED TOPSOIL THE SAME DAY THEY ARE DUG.

TOPSOIL SHALL AT FERTILE, FRIABLE NATURAL TOPSOIL OF CLAY LOAM CHARACTER CONTAINING AT LEAST 5% BUT NOT MORE THAN 20% BY WEIGHT OF ORGANIC MATTER WITH A PH RANGE FROM 6.0 TO 7.0. TOPSOIL SHALL BE FREE OF CLAY LUMPS, COURSE SAND, STONES, PLANT ROOTS, STICKS OR OTHER FOREIGN MATTER.

CARE FOR PLANTS BEFORE PLANTING

PLANTS DESIGNATED "BB" SHALL BE BALLED AND BURLAPPED WITH FIRM NATURAL BALLS OF EARTH. CRACKED, LOOSENED OR BROKEN BALLS SHALL NOT BE PLANTED. THEY SHALL BE MARKED WITH SPRAY PAIN AND IMMEDIATELY REMOVED FROM THE JOB SITE. IMMEDIATELY FOLLOWING DELIVERY AT THE JOB SITE, ALL PLANTS THAT WILL NOT BE PLANTED THAT SAME DAY SHALL BE "HEELED IN" WITH SHREDDED BARK OR MOIST SOIL AND KEPT MOIST UNTIL PLANTED.

THE TRUNKS AND BRANCHES OF ALL TREES SHALL BE PROTECTED FROM INJURY OF ANY KIND DURING ALL OPERATIONS. THE OWNER'S REPRESENTATIVE SHALL REJECT ANY TREES THAT ARE INJURED.

THE CONTRACTOR IS RESPONSIBLE FOR PLANTING MATERIALS PLUMB. SET THE TOP OF THE ROOT BALL AT OR SLIGHTLY HIGHER THAN THE SURROUNDING GRADE. PLANTS SHALL BE FACED TO GIVE THE BEST APPEARANCE OR RELATIONSHIP TO ADJACENT STRUCTURES. NO FILLING WILL BE PERMITTED AROUND TRUNK OR STEMS. WHEN THE PLANT HAS BEEN PROPERLY SET, THE HOLE SHALL BE BACKFILLED TO 1/2 THE DEPTH OF THE BALL WITH PREPARED TOPSOIL MIXTURE, FIRMLY PACKED AND WATERED-IN AT TIME OF PLANTING. LOOSED AND REMOVE BURLAP AND LACING FROM UPPER 1/3 OF THE ROOT BALL. BACKFILL WITH PREPARED TOPSOIL, WHICH AFTER COMPACTION IS FLUSH WITH THE SURROUNDING GROUND.

ALL PLANT MATERIAL SHALL BE ENCIRCLED WITH A 5" MINIMUM COVERING OF NON-DYED SHREDDED BARK MULCH TO 6" OUTSIDE THE PLANTING HOLE, TAPERING MULCH TO 2" AROUND THE TRUNK OF ALL PLANTS. SUBMIT SAMPLE TO THE OWNER'S REPRESENTATIVE FOR APPROVAL BEFORE PLACEMENT. WOOD CHIPS SHALL NOT BE ALLOWED ON THIS JOB. MULCH SHALL BE TREATED WITH PRE-EMERGENT HERBICIDE.

WRAPPING DECIDUOUS TREES

TREE WRAP SHALL COVER TRUNKS OF ALL DECIDUOUS TREES BEGINNING BELOW THE SOIL LINE JUST ABOVE THE ROOTS. TIE WITH TWINE IN 5 PLACES, INCLUDING THE TOP AND BOTTOM OF WRAPPING. MASKING TAPE OR WIRE WILL NOT BE ALLOWED.

BRACING AND GUYING

GUYING SHALL BE EMPLOYED TO PREVENT LEANING OR LOOSENING OF THE TREE FROM THE BALL. BRACING MATERIAL SHALL BE T-POSTS PAINTED GREEN. GUYING MATERIAL SHALL BE 12 GAUGE WIRE AND GARDEN HOSE 1/2 INCH DIAMETER. GUY WIRE SHALL BE ENCASED IN HOSE TO PREVENT DIRECT CONTACT WITH THE TREE. DECIDUOUS TREES SHALL BE BRACED OR GUYED IMMEDIATELY AFTER THE TREE WRAPPING IS COMPLETE.

STEEL LANDSCAPE EDGING

4" STEEL LANDSCAPE EDGING SHALL BE USED ON THIS PROJECT. ALUMINUM OR PLASTIC EDGING WILL NOT BE ALLOWED.

UPON COMPLETION, ALL PLANT MATERIAL MUST BE PRUNED. THE AMOUNT OF PRUNING SHALL BE LIMITED TO THE MINIMUM NECESSARY TO REMOVE DEAD OR INJURED BRANCHES AND TO COMPENSATE FOR THE LOSS OF ROOTS FROM TRANSPLANTING. ALL CUTS SHALL BE MADE FLUSH LEAVING NOT STUBS. PRUNING PAIN SHALL NOT BE USED.

FINISHING AND CLEANING UP

IMMEDIATELY UPON COMPLETION OF THE WORK, THE CONTRACTOR SHALL CLEAN UP THE AREA OF SURPLUS MATERIALS. THE CONTRACTOR SHALL REPAIR AND RE-ESTABLISH TURF IN RUTTED AREAS.

THE LANDSCAPE INSTALLATION CONTRACTOR SHALL REPLACE ALL UNHEALTHY VEGETATION AND PLANTINGS WITHIN ONE (1) YEAR OF INITIAL PLANTING OR SUBSEQUENT PLANTING PERIOD.



30' 60' SCALE: 1" = 30'

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APPLICANT: ALEXANDER CLOSE

DR


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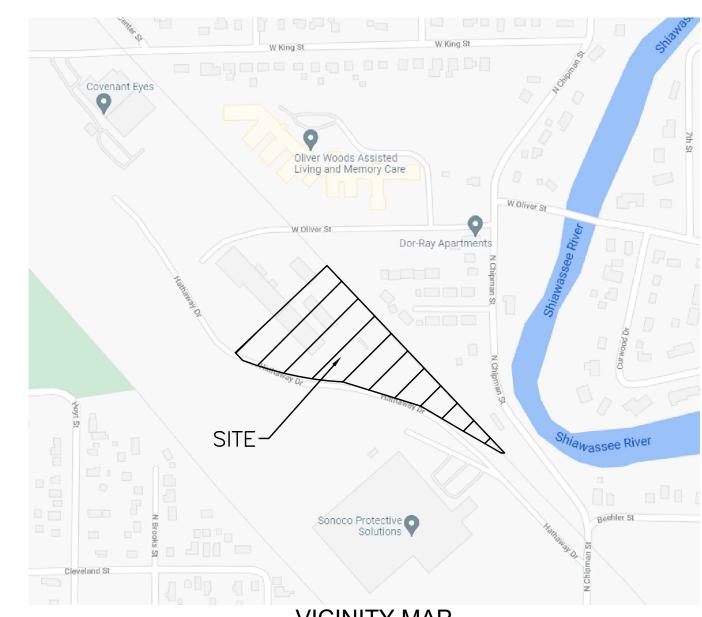
11/24/21 SPA/SLU

DATE: DRAWN: ACA CHECKED: ACA SCALE: 1"=30' JOB NO: 2021-139

SHEET TITLE : SITE LIGHTING AND LANDSCAPE PLAN



COMPLETENESS OR ACCURACY THEREOF.

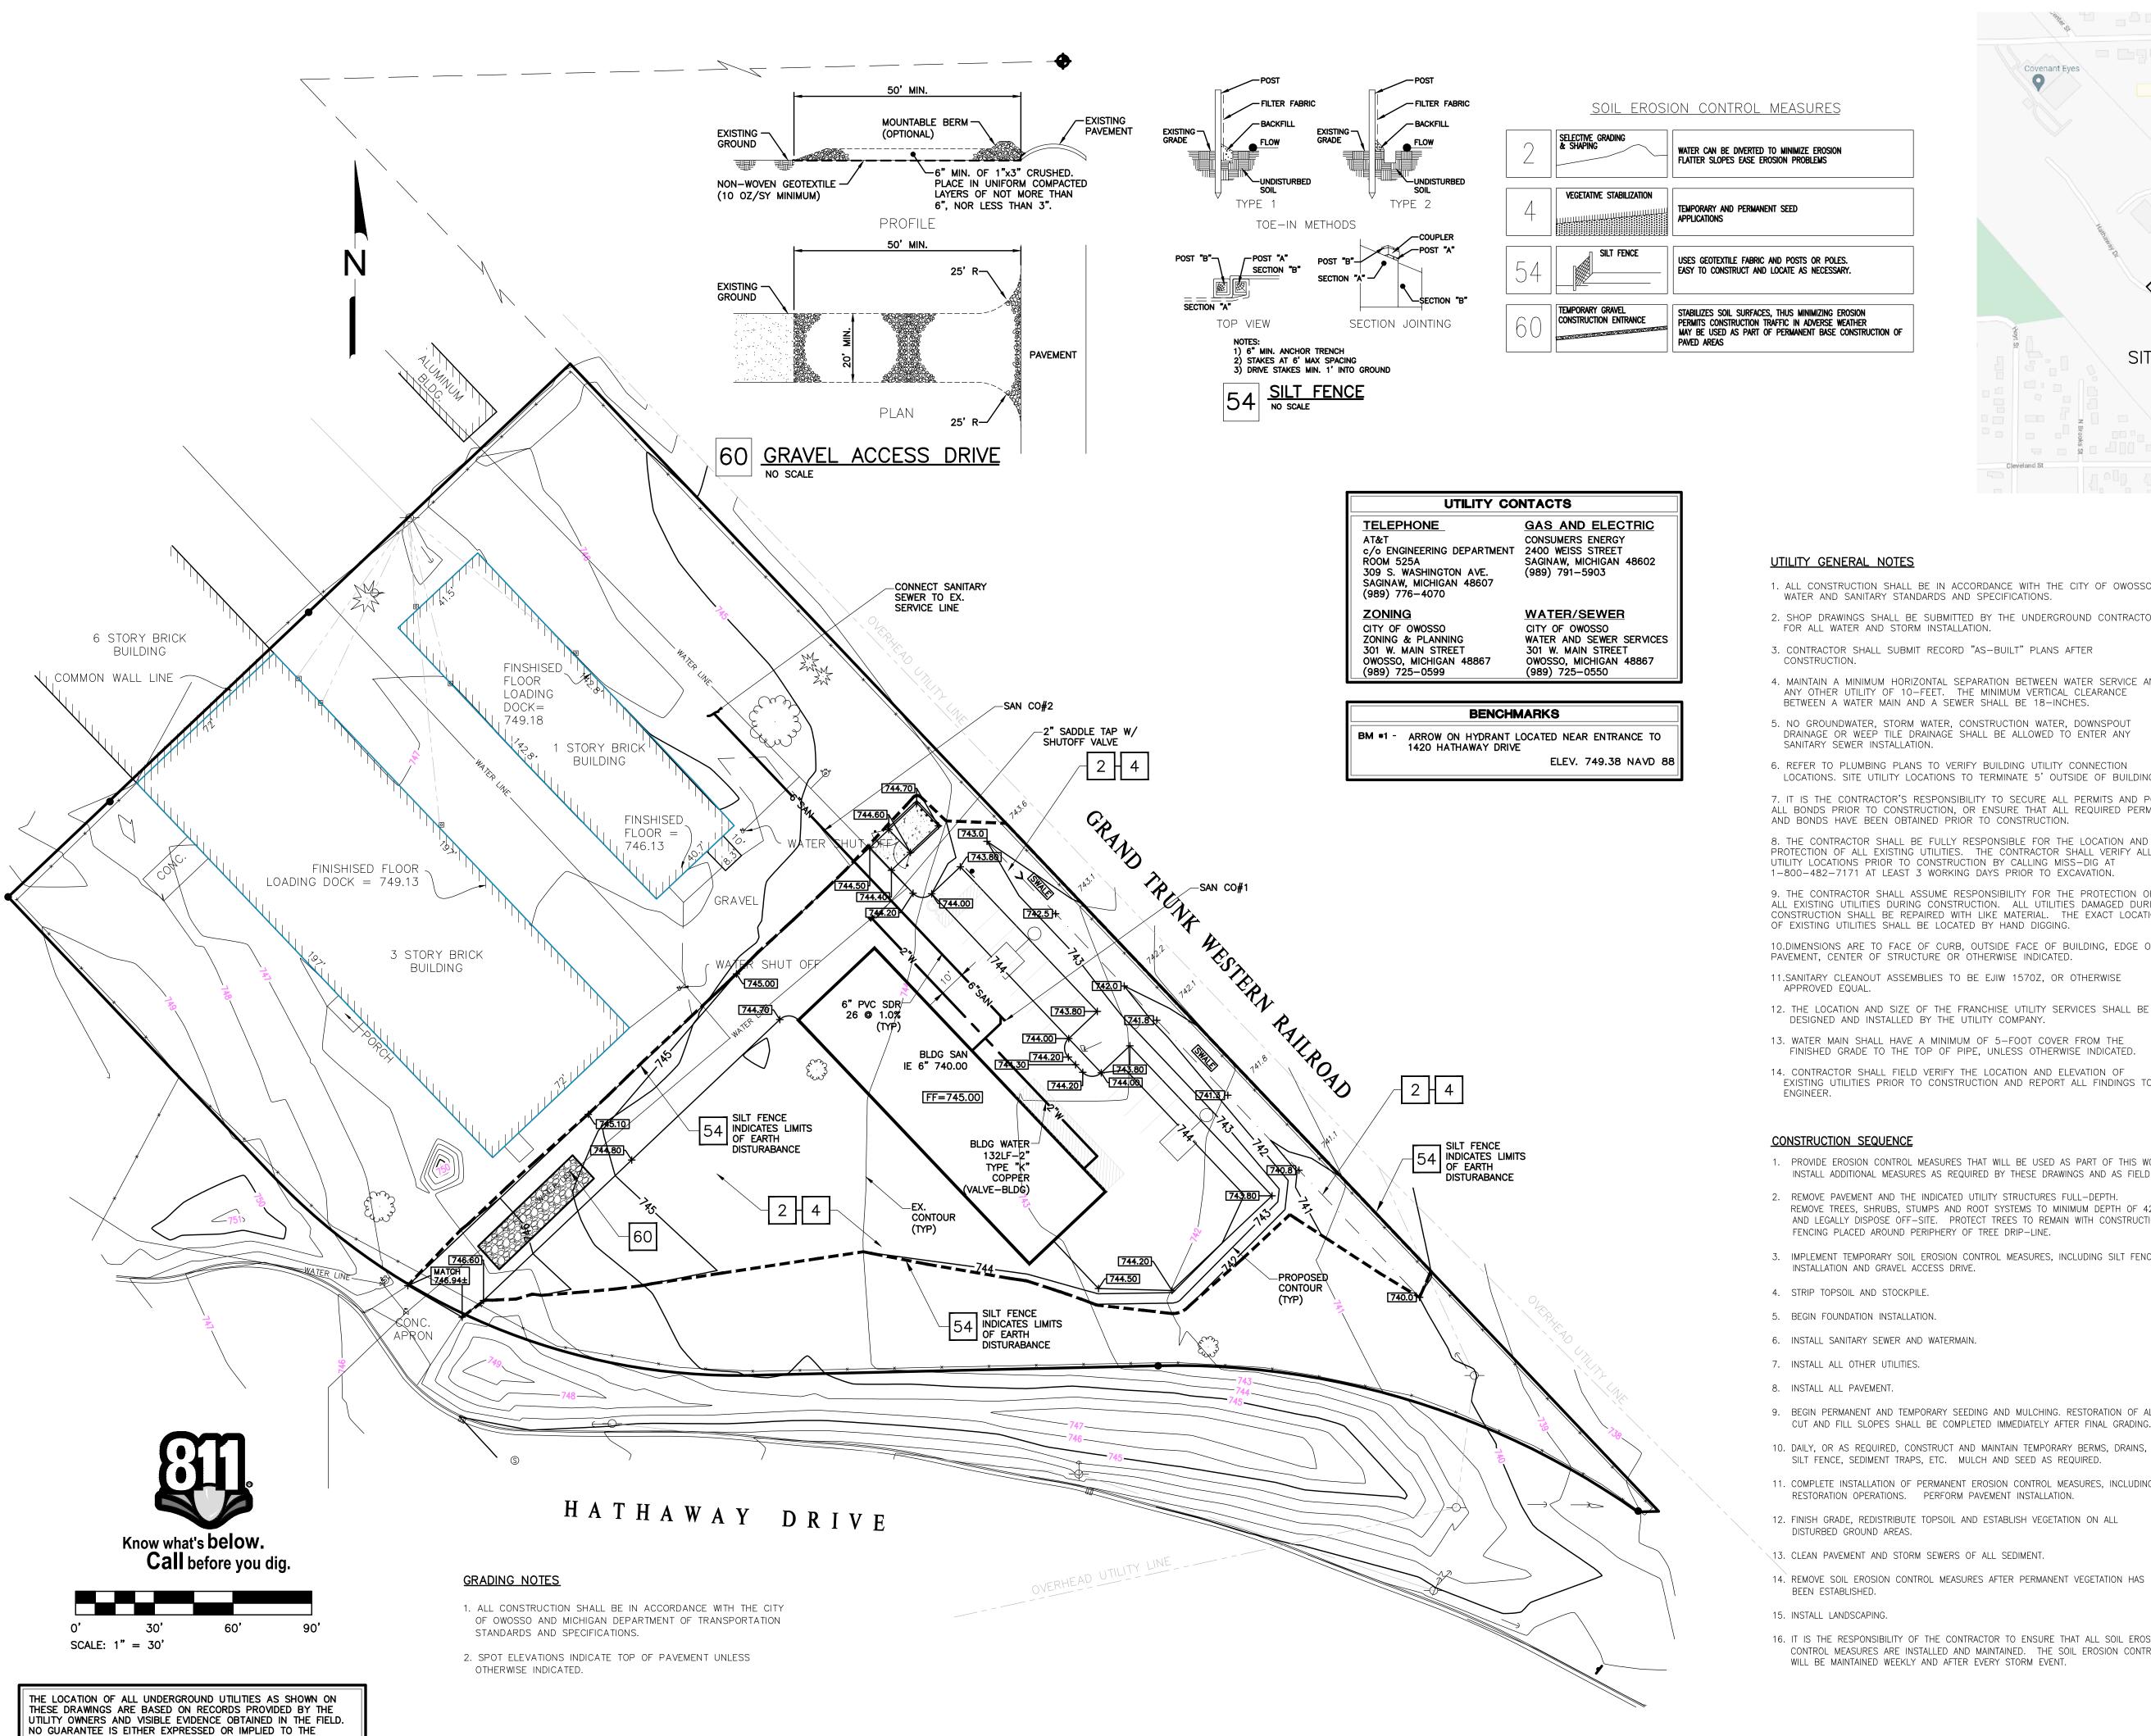

UTILITY GENERAL NOTES

1. ALL CONSTRUCTION SHALL BE IN ACCORDANCE WITH THE CITY OF OWOSSO WATER AND SANITARY STANDARDS AND SPECIFICATIONS.

2. SHOP DRAWINGS SHALL BE SUBMITTED BY THE UNDERGROUND CONTRACTOR FOR ALL WATER AND STORM INSTALLATION.

3. CONTRACTOR SHALL SUBMIT RECORD "AS-BUILT" PLANS AFTER

4. MAINTAIN A MINIMUM HORIZONTAL SEPARATION BETWEEN WATER SERVICE AND ANY OTHER UTILITY OF 10—FEET. THE MINIMUM VERTICAL CLEARANCE BETWEEN A WATER MAIN AND A SEWER SHALL BE 18-INCHES.

5. NO GROUNDWATER, STORM WATER, CONSTRUCTION WATER, DOWNSPOUT DRAINAGE OR WEEP TILE DRAINAGE SHALL BE ALLOWED TO ENTER ANY SANITARY SEWER INSTALLATION.

6. REFER TO PLUMBING PLANS TO VERIFY BUILDING UTILITY CONNECTION LOCATIONS. SITE UTILITY LOCATIONS TO TERMINATE 5' OUTSIDE OF BUILDING.

7. IT IS THE CONTRACTOR'S RESPONSIBILITY TO SECURE ALL PERMITS AND POST ALL BONDS PRIOR TO CONSTRUCTION, OR ENSURE THAT ALL REQUIRED PERMITS AND BONDS HAVE BEEN OBTAINED PRIOR TO CONSTRUCTION.

8. THE CONTRACTOR SHALL BE FULLY RESPONSIBLE FOR THE LOCATION AND PROTECTION OF ALL EXISTING UTILITIES. THE CONTRACTOR SHALL VERIFY ALL UTILITY LOCATIONS PRIOR TO CONSTRUCTION BY CALLING MISS-DIG AT 1-800-482-7171 AT LEAST 3 WORKING DAYS PRIOR TO EXCAVATION.

9. THE CONTRACTOR SHALL ASSUME RESPONSIBILITY FOR THE PROTECTION OF ALL EXISTING UTILITIES DURING CONSTRUCTION. ALL UTILITIES DAMAGED DURING CONSTRUCTION SHALL BE REPAIRED WITH LIKE MATERIAL. THE EXACT LOCATION OF EXISTING UTILITIES SHALL BE LOCATED BY HAND DIGGING.

10.DIMENSIONS ARE TO FACE OF CURB, OUTSIDE FACE OF BUILDING, EDGE OF PAVEMENT, CENTER OF STRUCTURE OR OTHERWISE INDICATED. 11.SANITARY CLEANOUT ASSEMBLIES TO BE EJIW 1570Z, OR OTHERWISE

12. THE LOCATION AND SIZE OF THE FRANCHISE UTILITY SERVICES SHALL BE DESIGNED AND INSTALLED BY THE UTILITY COMPANY.

13. WATER MAIN SHALL HAVE A MINIMUM OF 5-FOOT COVER FROM THE

FINISHED GRADE TO THE TOP OF PIPE, UNLESS OTHERWISE INDICATED.

14. CONTRACTOR SHALL FIELD VERIFY THE LOCATION AND ELEVATION OF EXISTING UTILITIES PRIOR TO CONSTRUCTION AND REPORT ALL FINDINGS TO

CONSTRUCTION SEQUENCE

APPROVED EQUAL.

1. PROVIDE EROSION CONTROL MEASURES THAT WILL BE USED AS PART OF THIS WORK. INSTALL ADDITIONAL MEASURES AS REQUIRED BY THESE DRAWINGS AND AS FIELD

2. REMOVE PAVEMENT AND THE INDICATED UTILITY STRUCTURES FULL-DEPTH. REMOVE TREES, SHRUBS, STUMPS AND ROOT SYSTEMS TO MINIMUM DEPTH OF 42" AND LEGALLY DISPOSE OFF-SITE. PROTECT TREES TO REMAIN WITH CONSTRUCTION FENCING PLACED AROUND PERIPHERY OF TREE DRIP-LINE.

3. IMPLEMENT TEMPORARY SOIL EROSION CONTROL MEASURES, INCLUDING SILT FENCE INSTALLATION AND GRAVEL ACCESS DRIVE.

4. STRIP TOPSOIL AND STOCKPILE

5. BEGIN FOUNDATION INSTALLATION.

6. INSTALL SANITARY SEWER AND WATERMAIN.

7. INSTALL ALL OTHER UTILITIES.

8. INSTALL ALL PAVEMENT.

9. BEGIN PERMANENT AND TEMPORARY SEEDING AND MULCHING. RESTORATION OF ALL CUT AND FILL SLOPES SHALL BE COMPLETED IMMEDIATELY AFTER FINAL GRADING.

SILT FENCE, SEDIMENT TRAPS, ETC. MULCH AND SEED AS REQUIRED.

11. COMPLETE INSTALLATION OF PERMANENT EROSION CONTROL MEASURES, INCLUDING RESTORATION OPERATIONS. PERFORM PAVEMENT INSTALLATION.

12. FINISH GRADE, REDISTRIBUTE TOPSOIL AND ESTABLISH VEGETATION ON ALL

DISTURBED GROUND AREAS. 13. CLEAN PAVEMENT AND STORM SEWERS OF ALL SEDIMENT.

14. REMOVE SOIL EROSION CONTROL MEASURES AFTER PERMANENT VEGETATION HAS BEEN ESTABLISHED.

15. INSTALL LANDSCAPING.

16. IT IS THE RESPONSIBILITY OF THE CONTRACTOR TO ENSURE THAT ALL SOIL EROSION CONTROL MEASURES ARE INSTALLED AND MAINTAINED. THE SOIL EROSION CONTROLS WILL BE MAINTAINED WEEKLY AND AFTER EVERY STORM EVENT.

VICINITY MAP SCALE: NO SCALE

MAINTENANCE NOTES

1. <u>SOIL STOCKPILES</u> PERIODIC INSPECTIONS SHOULD BE DONE TO ENSURE EXCESSIVE EROSION HAS NOT OCCURRED. IF RUNOFF OR WIND EROSION HAS OCCURRED, REDUCE THE SIDE SLOPES OF THE SPOIL PILE, OR RE-STABILIZE THE STOCKPILE BY PROVIDING TEMPORARY SEEDING.

WHEN FILTER FENCING IS USED AROUND A SPOIL PILE, PERIODIC CHECKS SHOULD BE MADE TO ENSURE THAT PIPING HAS NOT OCCURRED UNDER THE FENCING, AND TO ENSURE THE FENCE HAS NOT COLLAPSED DUE TO SOIL SLIPPAGE OR ACCESS BY CONSTRUCTION EQUIPMENT. REPAIR ANY DAMAGED FENCING IMMEDIATELY.

BERMS AT THE BASE OF THE SPOIL PILE WHICH BECOME DAMAGED SHOULD BE REPLACED.

O PREVENT DUST FROM BECOMING A PUBLIC NUISANCE AND CAUSING OFF-SITE DAMAGES, DUST CONTROL SHOULD BE ONGOING DURING EARTH CHANGE ACTIVITIES.

SILT FENCE SHALL BE INSTALLED IN ACCORDANCE WITH MANUFACTURER'S

SILT FENCES SHOULD BE INSPECTED IMMEDIATELY AFTER EACH RAINFALL AND SEVERAL TIMES DURING PROLONGED RAINFALLS.

THE FENCE IS SAGGING OR THE SOIL HAS REACHED ONE HALF (1/2) THE HEIGHT OF THE FABRIC, THE SOIL BEHIND THE FABRIC MUST BE REMOVED AND DISPOSED OF IN A STABLE UPLAND SITE. THE SOIL CAN BE ADDED TO THE SOIL STOCKPILE.

IF THE FABRIC IS BEING UNDERCUT (I.E. IF WATER IS SEEPING UNDER THE FENCE), THE FENCE SHOULD BE REMOVED AND REINSTALLED FOLLOWING THE PROCEDURES GIVEN ABOVE.

FABRIC WHICH DECOMPOSES OR OTHERWISE BECOMES INEFFECTIVE SHOULD BE REMOVED AND REPLACED WITH NEW FILTER FABRIC

SILT FENCES SHOULD BE REMOVED ONCE VEGETATION IS WELL ESTABLISHED AND THE UP-SLOPE AREA IS FULLY STABILIZED.

NEWLY SEEDED AREAS NEED TO BE INSPECTED FREQUENTLY FOR THE FIRST FEW MONTHS TO ENSURE THE GRASS IS GROWING. IF THE SEEDED AREA IS DAMAGED DUE TO RUNOFF, ADDITIONAL STORMWATER MEASURES MAY BE NEEDED. SPOT SEEDED CAN BE DONE ON SMALL AREAS TO FILL IN BARE SPOTS WHERE GRASS DIDN'T GROW PROPERLY.

5. MULCHING
MULCHED AREAS SHOULD BE CHECKED FOLLOWING EACH RAIN TO ENSURE THE MULCH IS STAYING IN PLACE. ADDITIONAL TACKING MATERIALS OR NETTING MAY NEED TO BE APPLIED TO HOLD THE MULCH

CONSTRUCTION ENTRANCE PROPER MAINTENANCE MAY INCLUDE ADDING ADDITIONAL LAYERS OF STONE WHEN THE ORIGINAL STONE BECOMES COVERED WITH MUD. AFTER EACH STORM EVENT, INSPECT THE ROAD FOR EROSION AND MAKE ANY NECESSARY REPAIRS. ALL SEDIMENT DROPPED OR ERODED ONTO

PUBLIC RIGHT-OF-WAY SHOULD BE REMOVED IMMEDIATELY BY SWEEPING.

SOIL EROSION & SEDIMENTATION CONTROL NOTES

1. ALL EROSION CONTROL MEASURES SHALL BE CONSTRUCTED AND MAINTAINED IN ACCORDANCE WITH THE AUTHORITY WITH JURISDICTION STANDARDS AND SPECIFICATIONS.

DAILY INSPECTIONS SHALL BE MADE BY THE CONTRACTOR TO DETERMINE THE EFFECTIVENESS OF EROSION AND SEDIMENT CONTROL MEASURES. ANY NECESSARY REPAIRS SHALL BE PERFORMED WITHOUT DELAY.

3. ANY EROSION OR SEDIMENT FROM WORK ON THIS SITE SHALL BE CONTAINED ON THE SITE AND NOT ALLOWED TO COLLECT ON ANY OFF-SITE AREAS OR IN WATERWAYS. WATERWAYS INCLUDE BOTH NATURAL AND MANMADE OPEN DITCHES, STREAMS, STORM DRAINS, LAKES AND PONDS.

4. CONTRACTOR SHALL APPLY TEMPORARY EROSION AND SEDIMENTATION CONTROL MEASURES AS REQUIRED AND AS DIRECTED ON THESE PLANS. CONTRACTOR SHALL REMOVE TEMPORARY MEASURES AS SOON AS PERMANENT STABILIZATION OF SLOPES, DITCHES AND OTHER EARTH CHANGES HAVE BEEN ESTABLISHED.

5. AFTER ALL TEMPORARY EROSION CONTROL MEASURES HAVE BEEN INSTALLED, THE CONTRACTOR SHALL CONTACT THE AUTHORITY WITH JURISDICTION FOR AN INSTALLATION INSPECTION.

6. DUST CONTROL SHALL BE EXERCISED AT ALL TIMES WITHIN THE PROJECT BY THE CONTRACTOR.


7. ALL MUD, DIRT AND DEBRIS TRACKED ONTO EXISTING ROADS SHALL BE PROMPTLY REMOVED BY THE CONTRACTOR NO LESS THAN ON A DAILY BASIS. ALL MUD, DIRT AND DEBRIS TRACKED OR SPILLED ONTO PAVED SURFACES WITHIN THIS SITE SHALL BE PROMPTLY REMOVED BY THE CONTRACTOR.

8. PERMANENT EROSION CONTROL MEASURES SHALL BE COMPLETED WITHIN 15 CALENDAR DAYS AFTER FINAL GRADING OR EARTH MOVING ACTIVITY HAS BEEN COMPLETED. A FINAL INSPECTION SHALL BE SCHEDULED BY THE CONTRACTOR.

9. AUTHORITY WITH JURISDICTION SHALL INSPECT ALL SOIL EROSION CONTROL MEASURES. UPON THEIR DIRECTION, ADDITIONAL MEASURES SHALL BE CONSTRUCTED AND MAINTENANCE WORK SHALL BE PERFORMED TO ENSURE COMPLIANCE WITH ALL PERMIT REQUIREMENTS.

Avanti Developmen Group, LLC

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REPARED UNDER THE DIRECTION OF: ANDREW ANDRE, P.E. MI #47380

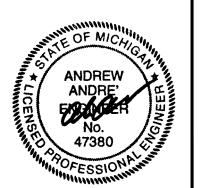APPLICANT:

ALEXANDER CLOSE

DR IAWAY D MI 48867 Ξ MA FA 142 OW

11/24/21

ISSUED FOR

SPA/SLU

DRAWN: ACA CHECKED: ACA SCALE: 1"=30' JOB NO: 2021-139 SHEET TITLE : **GRADING AND UTILITY** PLAN

Date: Nov 12, 2021 1:29:09 PM Store: WIXOM 10400 ASSEMBLY PARK DR

WIXOM, MI 48393 Ph: 248-344-1140

How to purchase at the store

1. Take this packet to any Menards store. 2. Have a building materials team member enter the design number into The Post Frame Request Form on the Midwest Manufacturing 3. Apply the design to System V to create the SOCs.


Design #: 332051603959 **Estimated price: \$42,177.66 *** *Today's estimated price, future pricing may go up or down. Tax, labor,

and delivery not included.

How to recall and purchase a saved design at home

1. Go to Menards.com. 2. Log into your account.

3. Go to Saved Designs under the Welcome Login menu. 4. Select the saved design to load back into the estimator. 5. Add your building to the cart and purchase.

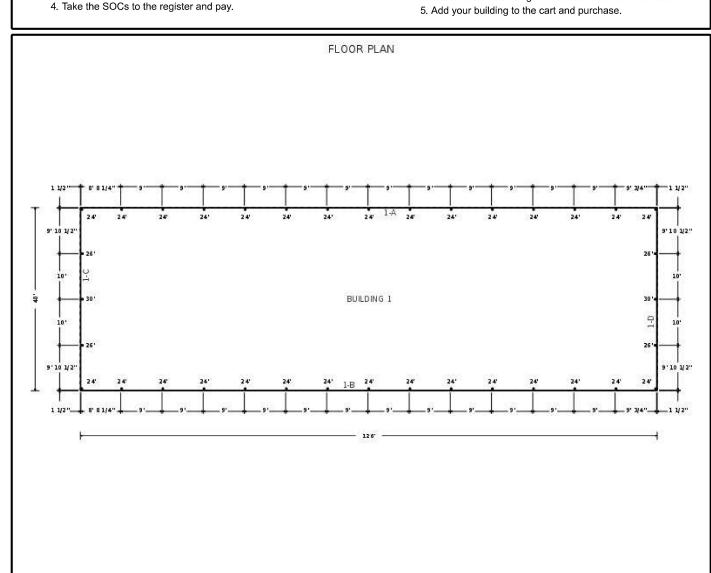

MENARDS Design #: 332051603959 Store: WIXOM

Code Exempt

40 ft

126 ft

None

None

None

Post Frame Building Estimate Date: Nov 12, 2021 1:29:09 PM

o. Longui.	12010
4. Inside Clear Height:	17 ft
5. Floor Finish:	Concrete
6. Floor Thickness:	4 in
7. Post Foundation:	Post Embedded
8. Post Embedment Depth:	4 ft
9. Footing Pad Size:	14 in x 4 in
Wall Information	
1. Post Type:	Columns
2. Post Spacing:	9 ft
3. Girt Type:	Flat
4. Exterior Wall Panel:	Pro-Rib
5. Exterior Wall Color:	Galvanized
6. Wainscot Size:	36 in
7. Wainscot Color:	Galvanized
8. Sidewall B Wainscot:	Yes
9. Sidewall A Wainscot:	Yes
10. Trim Color:	Galvanized
11. Endwall D Wainscot:	Yes
12. Endwall C Wainscot:	Yes
13. Sidewall A Eave Light:	None
14. Sidewall B eave light:	None
15. Wall Fastener Location:	In the Flat
16. Bottom Trim:	Yes
17. Eave Trim:	Yes
18. Gradeboard Type: 2x8 T	reated Gradeboard

Building Information

1. Building Use:

Interior Finish

2. Wall Liner Type:

1. Wall Insulation Type:

3. Roof Condensation Control:

2. Width:

Length:

Roof Information	
1. Pitch:	4/
2. Truss Spacing:	g
3. Roof Type:	Pro-F
4. Roof Color:	Galvaniz
5. Ridge Options:	Universal Ridge C
6. Roof Fastener Location:	On the F
7. Endwall Overhangs:	(
8. Sidewall Overhangs:	(
9. Skylight Size:	No
10. Ridge Vent Quantity:	No
11. Ceiling Liner Type:	No
12. Purlin Placement:	On Ed
13. Ceiling Insulation Type:	No


Accessories	
1. Outside Closure Strip:	Standard
2. Inside Closure Strip:	Standard
3. Gable Vent Type:	None
4. Cupola Size:	None
5. Gutters:	No
6. End Cap:	Yes
7. Snow Guard:	Yes
8. Mini Print:	Hardcopy and E-mail


Design #: 332051603959 Store: WIXOM

MENARDS

Post Frame Building Estimate Date: Nov 12, 2021 1:29:09 PM

Elevation Views

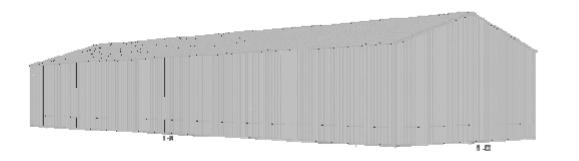

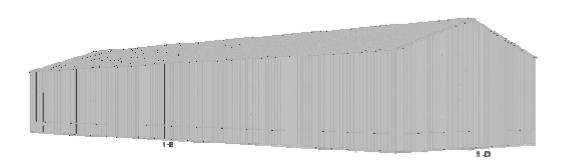

			M	y Company N Address 1 Address 2 City, State Zij				Truss: p40e JobName: new pf ends Date: 10/22/16 13:23 Page: 1 of 1	:46
SPAN 40-0-0	PITCH 4/12	QTY 1	OHL 0-0-0	OHR 0-0-0	CANT L 0-0-0	CANT R 0-0-0	PLYS 1	SPACING 48 in	WGT/PLY 225 lbs
	-			40-	0-0			-	
			-0-0 -0-0	-		20-0-0 40-0-0			
7-3-14	1x4 4x6 -		1.5x4 9x8	***************************************		3x8 - 1.5x4 6 3x8 2.6-0 2.6-0 3x8 - 11	5x 63x4 -	12 4 1x4 4x6 - 10	
	0-0-0			40- 40-				0-0-0	
20	vn to be Eagle 20 unless	otherwise noted.	Legre	Inc	824 00:0	71 0)		2013	
Loading (TCLL: 30 Snow(Ps/Pg): 2 TCDL: 4(rs BCLL: 0 BCDL: 5	Bldg Code: 8/50		CSI Summar TC: 0.57 (5-6) BC: 0.09 (15-16) Web: 0.84 (5-13)	y Defle Vert TL: Vert LL: Horz TL	0.01 in 0 in	L/ (loc) L/999 (10-11) L/999 9	Allow L/120 L/180	ea	
C SI Vebs SI Loads Sum This truss has b	PF 2100/1.8 2 x 6 PF #2 2 x 8 PF Stud 2 x 4 IMMARY Seen designed for the effects	of balanced and unbalanc	ed snow loads for hips/g	TC Bracing BC Bracing ables in accordance with	Sheathed or Purl ASCE7 - 10 with the	C, Purlin design by Others. ins at 10-0-0, Purlin design by following user defined input:	50 psf ground		
ippery surface. This truss has l isk Category I,	If the roof configuration differences the less speed for the effects to the less than 15 ft, Not End Zone Truss	ers from hip/gable, Buildi of wind loads in accordan s, Both end webs consider	ng Designer shall verify ce with ASCE7 - 10 wit ed. DOL= 1.60	snow loads. h the following user defin	ed input: 105 mph (F	1.2), DOL = 1.15. Unventilate actored), Exposure C, Enclose	d, Gable/Hip,		
estallation and te	ngorary bracing. orces Summary					ecople and property. See BCS: arcs). Only forces greater than 300		in this take	
2 24	0.558 -397 lbs 0.569 -520 lbs	5-6 0.569 6-8 0.558	-\$20 lbs -397 lbs			loo, only moot ground that 300	IDD III DIONK I		
Vebs 2-16	0.204 -923 lbs 0.542 -1,506 lbs	5-13 0.838 6-11 0.542	-935 lbs -1,506 lbs	8-10 0.204	923 lbs				
Notes:	therwise, do not cut or alter a	cyta es mambar as aluta	without prior process of	rom a Professional Fosio					
) Gable requires) Gable webs pl) Attach gable v) Bracing shows) When this true) Building Desig) Building Desig) Design assume (1) Creep has be (1) Due to negati	continuous bottom chord bea seed at 96 °CC, UNO. ebs with 2x6 20ga plates, U.1 is fer in-plane requirements, sha been chosen for quality, ner shall verify self weight of ner shall verify self weight of somitimum, x2 (flat orientate ner considered in the analysis, we reactions in gravity load ci- plift reactions based on MWI	aring. N.O. For out-of-plane require assurance inspection, the I fibe truss and other dead I fibe truss and other dead I inon, visually graded) purlis of this truss. assa, special connections to	ements, refer to BCSI-E Effective Tooth Count N load materials do not ex load materials do not ex ns attached to the top of	33 published by the SBC, Method per TPI 1-2002/A ceed TCDL 4 psf. ceed BCDL 5 psf. the TC at purlin spacing	A. 3.4 shall be used. shown with at least 2-	10d nails.			
) Listed wind u									

Design #: 332051603959 Store: WIXOM

MENARDS

Post Frame Building Estimate Date: Nov 12, 2021 1:29:09 PM

Congratulations, you have taken the first step towards making your new post frame building a reality!

 You have selected Menards to provide you with superior products produced by Midwest Manufacturing that will meet your needs. For a more detailed look at these premium products select one of the links below or visit us on the web at www.midwestmanufacturing.com.

Premium Steel Panels - Pro-Rib and Premium Pro-Rib steel panels are your best options for steel panels in the market.

- Steel Panels are Grade 80 (full hard steel).
- Prepaint zinc phosphate coating for superior paint paint adhesion available in multiple colors.
- Pro-Rib features a limited 40 year paint warranty.
- Premium Pro-Rib has a limited lifetime paint warranty.
- All painted panels are ENERGY STAR rated, using a Cool Chemistry paint system.
- Pro-Rib and Premium Pro-Rib panels are UL Certified for Wind Uplift UL 580, Fire Resistance UL 790, Impact Resistance of Roof UL 2218.
- Pro-Rib and Premium Pro-Rib panels are IRC and IBC compliant.

Engineered Trusses - Post frame trusses are specifically engineered to meet your application and

- All Midwest Manufacturing trusses can be supplied with engineered sealed prints.
- TPI approved and third party inspected.


Laminated Columns - Designed to replace standard treated posts as vertical supports in Post Frame Construction.

- Columns 20' or less are treated full length.
- Lifetime Warranty against rot and decay.
- Columns over 20' in length are reinforced with 20 gauge stainless steel plates at each splice location.
- Lower portion of columns treated for in ground use.
- Rivet Clinch Nails provide superior holding power.
- Columns provide superior truss to pole connection.

Pressure Treated Lumber - All treated post and grade board used in your building will safely and effectively resist decay.

- Treated to AWPA compliance.
- Post and grade board offer a lifetime warranty against rotting and decay.

*Delivery charge is not included in price. Items ordered to complete your building from vendors other than Midwest Manufacturing are not available for pickup from the plant.

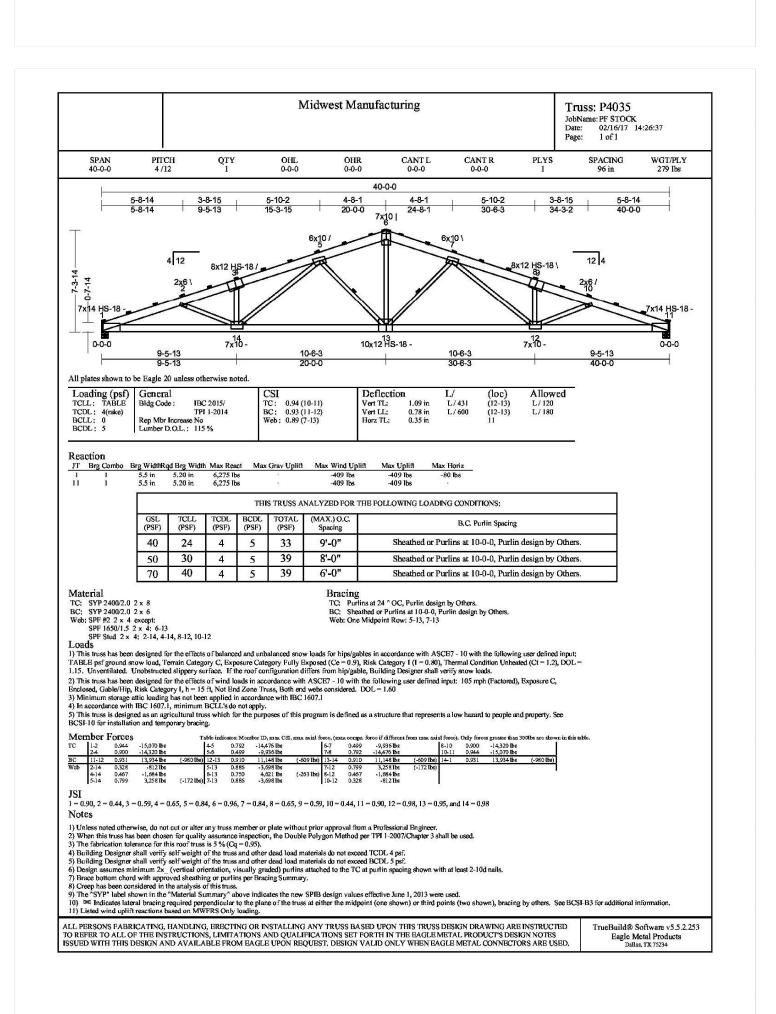



25280 Ryan Rd Warren, MI 48091

CLIENT:

Alexander Close

Contact:

alexander.m.close@gmail.com

PROJECT:

MARIJUANA CULTIVATION FACILITY - APPLICATION

LOCATION:

1420 HATHAWAY DR. OWOSSO, MI 48867

ARCHITECT: JESSICA ANN MARJI RA, NCARB

SHEET TITLE:

PRE-ENGINEERED BUILDING REFERENCE DRAWINGS

ISSUED:

• 011.24.21 ISSUED FOR SPA

DO NOT SCALE PRINTS USE FIGURED DIMENSIONS ONLY

PROJECT NO.

SHEET NO.

WALL TYPE LEGEND

EXISTING WALLS TO REMAIN (REPAIR WALL SURFACE)

REFER TO PARTITION SECTIONS ON A.30 I AS TAGGED ON FLOOR PLAN & VERIFY WITH OWNER

TYPICAL INTERIOR PARTITIONS

WALLS - TYPICAL

- 5/8" GYP. BD. BOTH SIDES OF 25 GA 4" METAL STUDS @ 24" O.C. TO UNDERSIDE OF EXISTING ROOF DECK.
- PROVIDE 5/8" GYP. BD. W/ EPOXY PAINT ON NON-CULTIVATION /

GENERAL SIDES OF PARTITIONS.
- INFILL STUD CAVITY W/ SPRAY FOAM INSULATION - TYPICAL
- PROVIDE FIRE CAULKING AT JOINTS/PENETRATIONS AT CORRIDOR

CULTIVATION AREA PARTITIONS

- CULTIVATION SIDE(S): DURACLAD 1/2" PVC INTERLOCKING LINER
PANELS W/ CONCEALED STAINLESS STEEL OR ZINC COATED, 1-INCH,
NO. 10 PANCAKE HEAD SCREW, ON 25 GA 4" MTL. STUDS @ 24" O.C.
TO UNDERSIDE OF EXISTING ROOF DECK.

- GENERAL SIDE: 5/8" GYP. BD.W/ EPOXY PAINT - INFILL STUD CAVITY W/ SPRAY FOAM INSULATION - TYPICAL

GENERAL NOTES

- I. CLEAN, PATCH AND REFINISH WALLS, FLOORS, CEILINGS, ETC. TO MATCH SURROUNDING FINISHES AT ALL LOCATIONS WHERE NEW ITEMS AFFECT EXISTING ELEMENTS.
- ITEMS AND MATERIALS NOT INDICATED AS NEW ARE TO BE CONSIDERED EXISTING TO REMAIN.
 ALL FINISHES AND FIXTURES ARE TO BE SELECTED BY OWNER AND
- MAY BE INDICATED IN THESE DRAWINGS FOR COORDINATION PURPOSES ONLY.

 4. PATCH ANY HOLES IN WALLS AFTER ROUGH-INS PAINT ALL EXPOSED
- GYPSUM WALL BOARD WITH WHITE PRIMER. FINAL COLOR/FNISH TO BE SELECTED BY OWNER.

 5. PROVIDE ADEQUATE BLOCKING IN WALLS FOR CABINETRY, SHELVING, OR WALL MOUNTED EQUIPMENT TO ACCOMMODATE MAXIMUM LOADS.
- COORDINATE LOCATIONS WITH ELECTRICAL/PLUMBING.

 5. PER OWOSSO ZONING ORDINANCE, CHAPTER 38 ZONING, ARTICLE XIII. I-I LIGHT INDUSTRIAL DISTRICTS"

"THE BUILDING SHALL BE EQUIPPED WITH AN ACTIVATED CARBON FILTRATION SYSTEM FOR ODOR CONTROL TO ENSURE THAT AIR LEAVING THE BUILDING THROUGH AN EXHAUST VENT FIRST PASSES THROUGH AN ACTIVATED CARBON FILTER."

FINISH NOTES

- INSULATION SHALL HAVE A FLAME SPREAD INDEX OF NOT MORE THAN 25 AND A SMOKE-DEVELOPED INDEX OF NOT MORE THAN 450 PER MBC SECTION 720.2.
- 2. INTERIOR FINISHES SHALL BE CLASS 'C' IN ACCORDANCE WITH MBC CHAPTER 8, TABLE 803. I I PER OCCUPANT LOAD OF LESS THAN 300.

BUILDING CODE ANALYSIS

PROJECT: MARIJUANA CULTIVATION FACILITY INTERIOR BUILD-OUT 1420 HATHAWAY DR., OWOSSO, MI 48867

APPLICABLE CODES: MBC 2015 ICC/ANSI 117.1-2009

MPC 2015 MMC 2015 IFGC 2014 w/ Pa

NEC 2014 w/ Part 8 Amendments
IFC 2015 as referenced in the 2015 MBC
NFPA 13-2013

MBC 2015 Ch 13

MEC 2015 Ch 4 \(\) Part 10.a Rules

(ANSI/ASHRAE 90.1-2013)

BUILDING INFORMATION

TOTAL BUILDING AREA: 5,040 SF GROSS
TOTAL USABLE AREA: 4,032 SF NET (80%)


PRE-ENG. BUILDING CONSTRUCTION TYPE: 2-B

PRE-ENG. METAL BUILDING CONSTRUCTION:
- EXTERIOR WALLS: METAL SIDING ON STEEL STUDS
- FLOOR: POLISHED CONCRETE SLAB
- ROOF: METAL ROOFING OVER STEEL TRUSSES

PROPOSED INTERIOR CONSTRUCTION:

- TYPICAL INTERIOR PARTITIONS: STEEL STUD W/ GYPSUM
BOARD OR PVC PANELS (SEE A.301 FOR PARTITION DETAILS)

- CEILING: GYP. BD. ON METAL DRYWALL SUSPENSION SYSTEM
AT 10'-0" A.F.F. - EPOXY PAINT

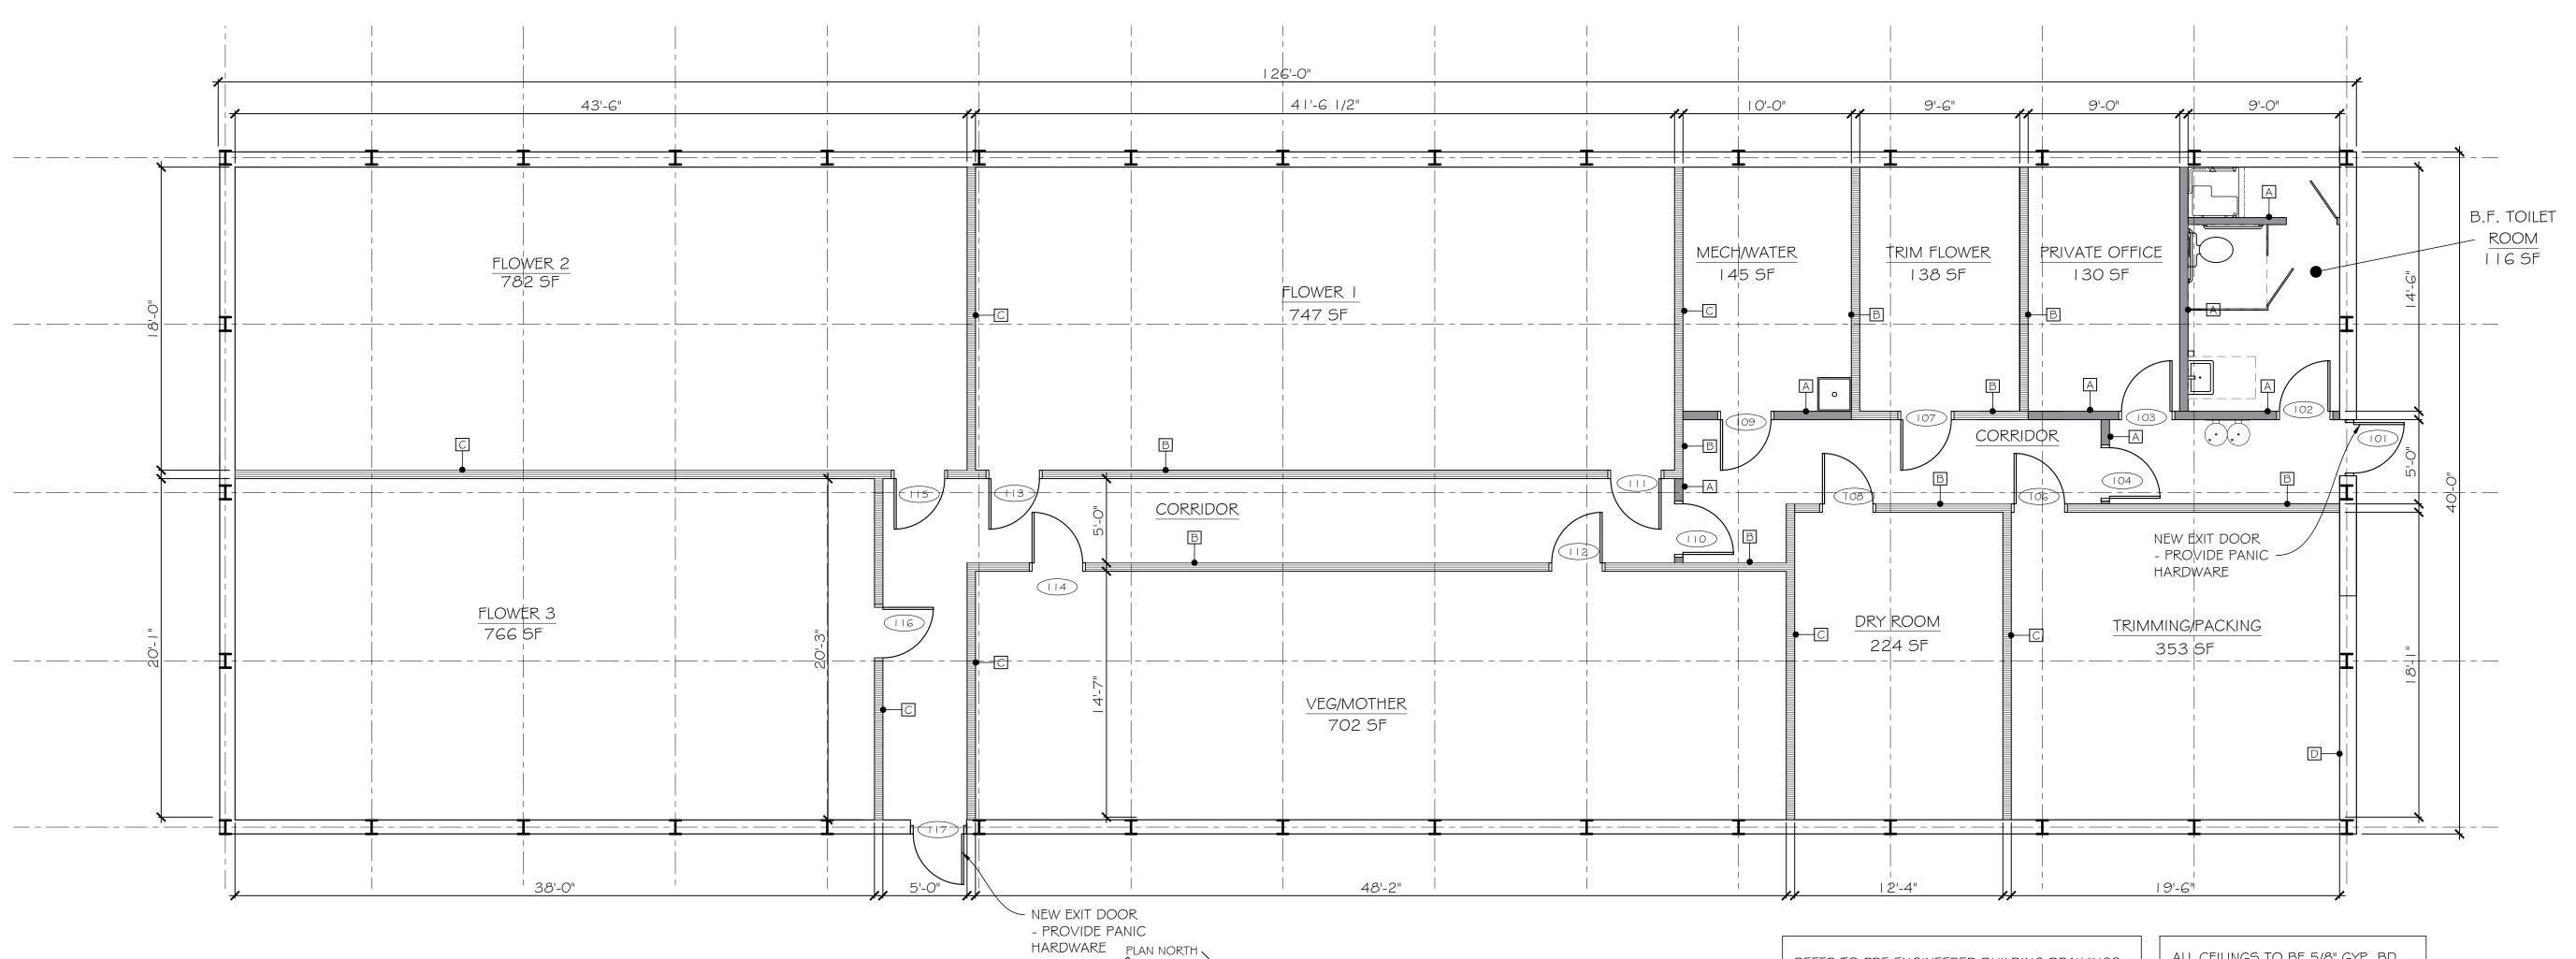

PROPOSED FLOOR PLAN

SCALE: 3/16" = 1'-0"

ALL CEILINGS TO BE 5/8" GYP. BD.
ON METAL DYRWALL SUSPENSION
SYSTEM, INSTALLED AT 10'-0" A.F.F.

REFER TO PRE-ENGINEERED BUILDING DRAWINGS

PROVIDED ON SHEET A. I OO FOR REFERENCE.

design group
mcidesigngroup@gmail.com

direct: 248.390.2243 25280 Ryan Rd Warren, MI 48091

CLIENT:

Alexander Close

Contact:

alexander.m.close@gmail.com

PROJECT:

MARIJUANA CULTIVATION FACILITY - APPLICATION

LOCATION:

1420 HATHAWAY DR.

OWOSSO, MI 48867

ARCHITECT:

JESSICA ANN MARJI
RA, NCARB

MI no: 1301059028



SHEET TITLE:

PROPOSED FLOOR PLAN

ISSUED:

• 011.24.21 ISSUED FOR SPA


DO NOT SCALE PRINTS USE FIGURED DIMENSIONS ONLY

PROJECT NO.

21019

SHEET NO.

A.101

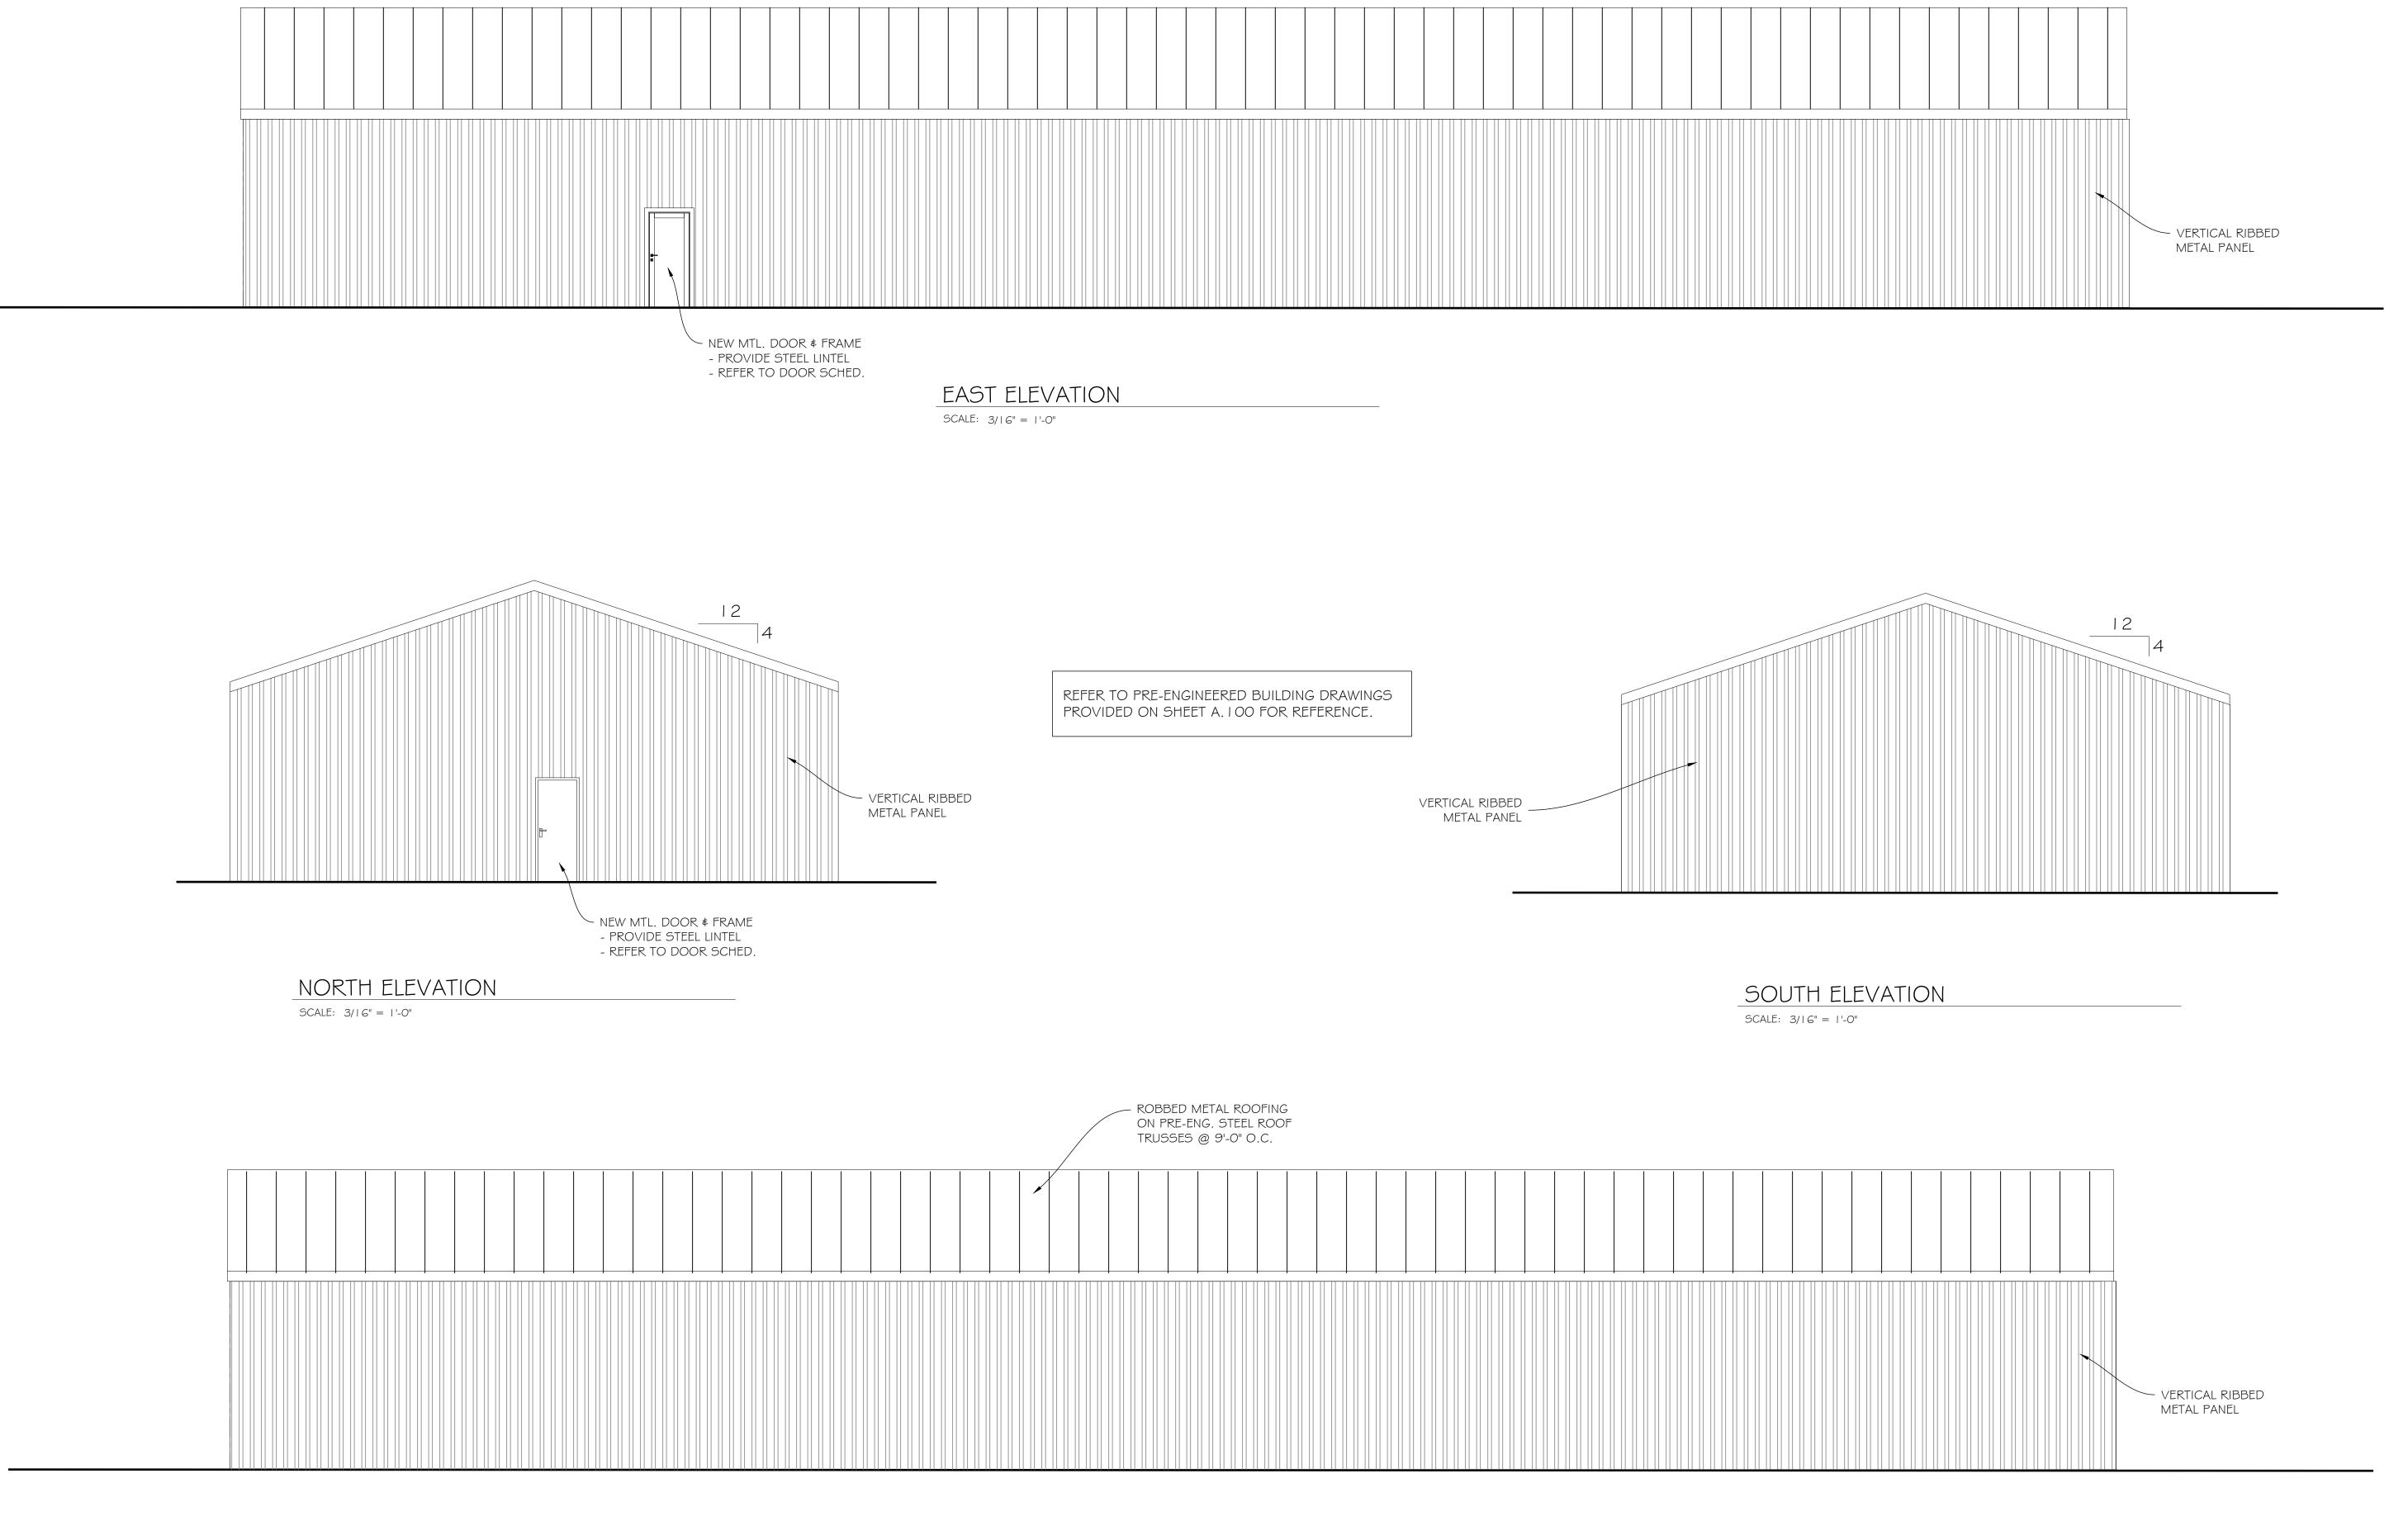

design group
mcidesigngroup@gmail.com
direct: 248.390.2243
25280 Ryan Rd
Warren, MI 48091

CLIENT:

Alexander Close

Contact: alexander.m.close@gmail.com

PROJECT:

MARIJUANA CULTIVATION FACILITY - APPLICATION

LOCATION:

1420 HATHAWAY DR. OWOSSO, MI 48867

ARCHITECT:

JESSICA ANN MARJI
RA, NCARB

MI no: 1301059028



SHEET TITLE:

EXTERIOR ELEVATIONS

ISSUED:

• 011.24.21 ISSUED FOR SPA

DO NOT SCALE PRINTS USE FIGURED DIMENSIONS ONLY

PROJECT NO.

21019

SHEET NO.

A.102

WEST ELEVATION

SCALE: 3/16" = 1'-0"



December 6, 2021

Planning Commission City of Owosso 301 W. Main Street Owosso, Michigan 48867

Subject: 1420 Hathaway Drive Site Plan Review. Approximately 2.5 acres, located on the north side

of Hathaway. Zoned I-1, Light Industrial.

Attention: Tanya Buckelew, Planning and Building Director

Dear Planning Commissioners:

At your request, we have completed our review of the above site plan build a new marijuana growing facility along Hathaway. The site development will include the construction of a new 5,120 sf building, 11 parking spaces, new landscaping and will be accessed from Hathaway. The property is currently zoned I-1, Light Industrial, where this use is a permitted land use.

The opinions in this report are based on a review of the site plan submitted by the applicant and conformance to ordinance standards. Please note that the applicant and their design professionals shall be responsible for the accuracy and validity of information presented with the application. In reaching a decision on the application, the Planning Commission should consider our comments along with those from other staff and consultants, additional information provided by the applicant, and your own findings based on ordinance standards as part of your deliberation.

REVIEW COMMENTS

Section 36-390 of the City of Owosso Zoning Ordinance lists the submittal requirements for site plan review. Based on our review of the proposal, discussions with Mr. Nathan Henne, City Manager, meetings with the applicant and a visit to the site, we offer the following comments for your consideration:

- 1. Information items. The site plan meets the informational requirements of the ordinance.
- **2. Area and Bulk**. The proposed site was reviewed in accordance with *Article 16, Schedule of Regulations,* as described in the following table.

	Required	Provided	Comments
1420 Hathaway (I-1 ZONING)			
Front Yard Building Setback	40 ft	40 ft	In compliance

Phone: 810-734-0000

Email: sprague@cibplanning.com

	Required	Provided	Comments
Side Yard Building Setback	20	26 ft and 69 ft	In compliance
Rear Yard Building Setback	0 ft.	24 ft.	In compliance
Maximum Building Height	40 ft.	17 ft	In compliance

- **3. Building Design & Materials.** The ordinance states that durable building materials which provide an attractive, quality appearance must be utilized. The proposed building materials are consistent with the City of Owosso Zoning Ordinance.
- **4. Building Height.** The proposed building complies with the maximum building height.
- 5. Mechanical Units. The Zoning Ordinance requires that all exterior mechanical equipment be screened. The applicant has not provided information regarding potential exterior mechanical equipment that has been seen with similar developments recently approved by the city. We would recommend as a condition of approval that applicant resubmit revised site plans depicting any and all proposed exterior mechanical equipment and the proposed methods for screening each proposed unit.
- **6. Dumpster**. The proposed dumpster meets ordinance requirements.
- 7. Site Lighting. Proposed lighting is in compliance with the Zoning Ordinance.
- **8.** Parking Lot Requirements. This requirement has been met.
- **9.** Landscaping. The landscaping plan is in compliance with the ordinance however, <u>if additional</u> landscaping needed to screen exterior mechanical equipment, that must be shown on the plan for final <u>approval</u>.
- **10. Other Approvals.** The proposed site plan must be reviewed and approved by the appropriate city departments, consultants, and agencies.

RECOMMENDATION

Based upon the above comments, we recommend approval of the 1420 Hathaway Drive Site Plan, conditioned upon the following:

- 1. Submission of a revised site plan that satisfactorily addresses the items in this letter, for administrative review and approval;
- 2. That the applicant show on the plan the location and method of screening for any and all proposed exterior mechanical equipment associated with the site development and operation,
- 3. That the landscaping plan be revised if landscaping will be utilized as a method of screening any proposed mechanical equipment; and
- 4. Review and approval by the appropriate city departments, consultants, and agencies.

City of Owosso Planning Commission 1420 Hathaway Drive Site Plan Review December 6, 2021 Page 3

If you have any further questions, please contact us at 810-734-0000.

Sincerely,

CIB Planning

Justin Sprague Vice President