

CITY OF OWOSSO PLANNING COMMISSION Regular Meeting Monday, July 25, 2022 at 6:30 p.m. AGENDA

- A. CALL TO ORDER
- B. PLEDGE OF ALLEGIANCE
- C. ROLL CALL
- D. APPROVAL OF AGENDA July 25, 2022
- E. APPROVAL OF MINUTES May 23, 2022
- F. ELECTION OF OFFICERS
- G. PUBLIC HEARINGS: NONE
- H. SITE PLAN REVIEWS:
 - 1. 702 W Main St
- I. ITEMS OF BUSINESS:
- J. COMMISSIONER/CITIZEN COMMENTS:
- K. ADJOURNMENT

Next regular meeting will be on Monday, August 22, 2022 at 6:30 p.m.

The City of Owosso will provide necessary reasonable auxiliary aids and services, such as signers for the hearing impaired and recordings of printed materials being considered at the meeting, to individuals with disabilities at the meeting/hearing upon seventy-two (72) hours' notice to the City of Owosso. Individuals with disabilities requiring auxiliary aids or services should contact the City of Owosso by writing or calling the following: Amy Kirkland, City Clerk, 301 W. Main St, Owosso, MI 48867 (989) 725-0500. The City of Owosso website is: www.ci.owosso.mi.us

MINUTES REGULAR MEETING OF THE OWOSSO PLANNING COMMISSION Monday, May 23, 2022 – 6:30 P.M.

CALL TO ORDER: Chairman Wascher called the meeting to order at 6:30 p.m.

PLEDGE OF ALLEGIANCE: Recited

ROLL CALL: Recording Secretary Molly Hier

MEMBERS PRESENT: Secretary Fear, Vice-Chair Livingston, Commissioners Taylor, Law and

Chairman Wascher

MEMBERS ABSENT: Commissioners Jenkins, Morris, Robertson, Schlaack

OTHERS PRESENT: Tanya Buckelew, Planning & Building Director & Justin Sprague, CIB

Planning

APPROVAL OF AGENDA:

MOTION BY VICE-CHAIR LIVINGSTON, SUPPORTED BY SECRETARY FEAR TO APPROVE THE AGENDA FOR May 23, 2022.

YEAS ALL. MOTION CARRIED.

APPROVAL OF MINUTES:

MOTION BY VICE-CHAIR LIVINGSTON SUPPORTED BY COMMISSIONER LAW TO APPROVE THE MINUTES FOR THE March 28, 2022 MEETING.

YEAS ALL. MOTION CARRIED.

ELECTION OF OFFICERS: (DUE JULY 2022)

SITE PLAN REVIEWS:

1. 701 S CHESTNUT ST

Develop 16, 1,250-square feet storage spaces in 4 buildings on the property. The site development will include the updating to an existing building, will utilize 9 existing parking spaces and add the proposed new buildings. The property is currently zoned I-1, Light Industrial, where this use is a permitted land use.

JUSTIN SPRAGUE, CIB PLANNING, OFFERED THE FOLLOWING REVIEW:

- 1. **Information items.** The site plan meets the informational requirements of the ordinance.
- **2. Area and Bulk**. The proposed site was reviewed in accordance with *Article 16, Schedule of Regulations*, as described in the following table.

701 S Chestnut State Street (I-1 Zoning)	Required	Provided	Comments
Front Yard Building Setback	40 ft.	95 ft.	In compliance
Side Yard Building Setback	20 ft.	20' & 20'	In compliance
Rear Yard Building Setback	50 ft.	100 ft.	In compliance
Maximum Building Height	40 ft.	16 ft.	In compliance

- 3. Building Design & Materials. The ordinance states that durable building materials which provide an attractive, quality appearance must be utilized. The proposed building materials are acceptable for the I-1 District
- 4. Building Height. The proposed building complies with the maximum building height.
- **5. Mechanical Units.** No new mechanical units are proposed on the plan.
- **6. Dumpster**. The proposed dumpster meets ordinance requirements.
- 7. Parking Lot Requirements. This requirement has been met.
- 8. Landscaping. It does not appear that any new landscaping is proposed.
- 9. Buffering. Per Section 38.389, a buffering wall of durable and high-quality materials is required along the property line separating the industrial district from the residential district. The site plan does not show any type of buffering wall or fence or a landscaped alternate screening type which is required along the eastern property line where the property is abutting residential.
- 10. Lighting. Site lighting appears to meet the ordinance standards. It is noted that all new lighting should be shielded and fixed at 90-degree angles toward the ground, not at a 45 degree or other degree angle from the pole or building.
- **11. Other Approvals.** The proposed site plan must be reviewed and approved by the appropriate city departments, consultants, and agencies.

RECOMMENDATION

Based upon the above comments, we recommend approval of the 701 S Chestnut Site Plan, conditioned upon the following:

- 1. Addition of a screening wall, fence or Planning Commission approved landscaping materials to satisfy buffering requirements of the Zoning Ordinance;
- 2. Clarification if any new landscaping is proposed;
- 3. That all light fixtures are fixed in a 90 degree to the ground, downward facing position; and
- 4. Review and approval by the appropriate city departments, consultants, and agencies

ADDITIONAL COMMENTS:

Justin Sprague stated the updated plan incorporate the proposed landscaping and posed the question to the Planning Commission if the suggested screening of staggered evergreen trees is enough buffering in their opinion.

Secretary Fear and Commissioner Taylor inquired as to what kind of evergreen would be used; exact species is unknown currently. Justin will send a list of acceptable species to the property owner, the review of trees can be done administratively.

Commissioner Law asked if outdoor storage is planned and if so trees would not be enough of a buffer. Mr. Gregorika stated that outdoor storage is not planned at this time.

Chairman Wascher confirmed there is not to be any additional water at the property other than in the existing building that will be used as an office.

Mr. Gregorika confirmed he has spoken with nearby property owners and the Drain Commissioner who have no issues with the development.

MOTION BY COMMISSIONER TAYLOR SUPPORTED BY COMMISSIONER LAW TO APPROVE THE SITE PLAN REVIEW FOR 701 S CHESTNUT STREET FOR THE ADDITION OF 16 INDOOR STORAGE UNITS (1,250 SQUARE FEET STORAGE SPACES IN FOUR (4) BUILDINGS) WITH FURTHER APPROVAL REQUIRED BY THE SHIAWASSEE COUNTY DRAIN COMMISSION FOR

ANY WATER RUNOFF FROM THE PROPERTY BE TIED IN UNDERGROUND TO THE DRAIN AND TREE SPECIES USED AS BUFFERING WILL BE REVIEWED ADMINSTRATIVELY.

YEAS: SECRETARY FEAR, COMMISSIONER LAW, VICE-CHAIR LIVINGSTON,

COMMISSIONER TAYLOR AND CHAIRMAN WASCHER

NAYS: NONE

RCV: 5-0 MOTION CARRIED

2. <u>1015 S WASHINGTON ST</u>

Add a 2,520 square foot warehouse to an existing building used for commercial purposes. The site development will include the warehouse addition, add new parking spaces and paving a new driveway. The property is currently zoned B-4, General Business, where this use is a permitted land use.

JUSTIN SPRAGUE, CIB PLANNING OFFERED THE FOLLOWING:

1. Information items. The site plan meets the informational requirements of the ordinance.

2. Area and Bulk. The proposed site was reviewed in accordance with Article 16, Schedule

of Regulations, as described in the following table.

1015 S. Washington Street (B4 Zoning)	Required	Provided	Comments
Front Yard Building Setback	15 ft.		In compliance, but not provided on plan
Side Yard Building Setback	-	10 ft.	In compliance
Rear Yard Building Setback	10 ft.		In compliance, but not shown on plan
Maximum Building Height	35 ft.		Appears in compliance, but not shown on plan

- 3. **Building Design & Materials.** The ordinance states that durable building materials which provide an attractive, quality appearance must be utilized. **The proposed building materials** are acceptable for the B-4 District
- 4. Building Height. The proposed building plan does not show the maximum building height and must be shown on the plan to demonstrate compliance.
- 5. **Mechanical Units.** No new mechanical units are proposed on the plan.
- 6. Dumpster. The site plan does not identify a dumpster location or any required screening. If a dumpster is proposed, the location and screening and truck circulation routes must be shown on the plan.
- 7. Parking Lot Requirements. The proposed expansion will require a total of 5 spaces and 6 have been provided, however none of the proposed spaces are shown as barrier free. At least one space should be dedicated to barrier free access.
- 8. Landscaping. It does not appear that any new landscaping is proposed.
- 9. **Buffering.** Per Section 38.389, a buffering wall of durable and high-quality materials is required along the property line separating the industrial district from the residential district. **The site plan** does not show any type of buffering wall or fence or a landscaped alternate screening type which is required along the eastern property line where the property is abutting residential

- 10. **Lighting.** The site plan does not indicate any proposed lighting. **It is noted that all new** lighting should be shielded and fixed at 90-degree angles toward the ground, not at a 45 degree or other degree angle from the pole or building.
- 11. **Other Approvals.** The proposed site plan must be reviewed and approved by the appropriate city departments, consultants, and agencies.

RECOMMENDATION

Based upon the above comments, we recommend approval of the 1015 S Washington Street Site Plan, conditioned upon the following:

- 1. An updated site plan with all dimensions shown on the plan including exact setback distances and building height;
- 2. Identification of proposed dumpster location, screening and truck routes for unloading the dumpster if one is proposed;
- 3. Dedication of one parking space for barrier free use;
- 4. Addition of a screening wall, fence or Planning Commission approved landscaping materials to satisfy buffering requirements of the Zoning Ordinance;
- 5. Clarification if any new landscaping is proposed;
- 6. That all light fixtures are fixed in a 90 degree to the ground, downward facing position; and
- 7. Final administrative review and approval of the updated site plan by the appropriate city departments, consultants, and agencies.

ADDITIONAL COMMENTS:

Chairman Wascher asked about the amount of traffic at the business due to the small size of the parking lot and the proposal of 6 parking spaces making the area tighter.

Business owner Travis Yaklin stated there would be almost no traffic other than the three delivery vehicles that will be pulling through the lift door in the loading/unloading zone.

Additionally, Mr. Yaklin made note that the existing shed will be removed from the property.

Justin Sprague clarified the number of parking spaces proposed (6) is required by the current ordinance.

Secretary Fear confirmed with Justin that the required parking spaces of a business would be addressed in the new Zoning Ordinance and will be reduced.

Additionally, Secretary Fear asked about the height of the new building; 18ft, existing building is 14ft.

Chairman Wascher confirmed the following: no boundary survey is required, exact setbacks to be provided in revised plans and there will not be any lighting in the newly proposed parking lot, only those attached to the building.

MOTION BY VICE-CHAIR LIVINGSTON SUPPORTED BY COMMISSIONER LAW TO APPROVE THE SITE PLAN REVIEW FOR 1015 S. WASHINGSTON STREET FOR THE ADDITION OF A 2,520 SQUARE FOOT WAREHOUSE PROVIDED THE CONDITIONS/REQUIREMENTS FROM THE CITY PLANNER AND CITY ENGINEER ARE MET UNDER FURTHER ADMINISTRATIVE REVIEW.

YEAS: COMMISSIONER LAW, VICE-CHAIR LIVINGSTON, COMMISSIONER

TAYLOR, SECRETARY FEAR AND CHAIRMAN WASCHER

NAYS: NONE

RCV: 5-0 MOTION CARRIED

ITEMS OF BUSINESS: NONE

COMMISSIONER/CITIZEN COMMENTS:

Secretary Fear asked for a status on the Matthews Building demolition.

Tanya Buckelew explained the remaining brick wall is load bearing and was an unexpected find by the demo crew; a temporary plan is being put in place to stabilize the wall until the property owners of the Matthews Building and their Architect can figure out how the wall can be safely removed without threatening the integrity of the remaining riverside building.

ADJOURNMENT:

MOTION BY COMMISSIONER TAYLOR SUPPORTED BY VICE-CHAIR LIVINGSTON TO ADJOURN AT 7:25 PM UNTIL THE NEXT MEETING ON JUNE 27, 2022.

YEAS ALL, MOTION CARRIED



SITE PLAN REVIEW APPLICATION AND CHECKLIST

CITY OF OWOSSO 301 W MAIN STREET OWOSSO, MI 48867 989-725-0535 building@ci.owosso.mi.us

> Site plan required for all commercial, industrial and multi-family residential

- > Application must be filed at least 25 days prior to a scheduled Planning Commission meeting for staff review and proper notices (see page 3 for submittal deadlines).
- > This application is submitted with one (1) copy of the complete site plan and appropriate fees.
- > Applicant shall also submit a digital version of the site plan.

Approval of the site plan is hereby reques	sted for the fol	llowing parcel of lar	nd in the City of Owosso.
Property Details:			
Name of Proposed Development: St Pa	ul's Church	n Parking Lot	
Property Street Address: 111 N. Howe	ell St.		
	·	Williams Add	
Site Area (in acres): 2.89 Parc	cel ID #: 050-6	660-013-001-00	Zoning: B-4
Ownership:	* 4,.		
Name: St Paul's Catholic Church co	ontact: Terry	Dumond	у.
Address: 111 N. Howell St., Owosso	, MI 48867		
Telephone No: 989-277-2687		Email: tdumond6	64@gmail.com
Applicant:			
Applicant (If different from owner above): as	s above		
Address:			
Telephone No:		Email address:	
Interest in Property (potential buyer/lease hole	der/potential le	ssee/other):	
Architect/Surveyor/Engineer preparing site	e plan:		· ·
Name: PEA Group, contact: Thom De	umond		
Address: 7927 Nemco Way, Brighton,	MI 48116		
Telephone No: 844-813-2949		Email: tdumond(@peagroup.com
Construction Proposed:			
☐ Residential ☐ I	Multi-family		□ Number of units
ℂχ Commercial		☐ Industrial	
Current use church		Proposed use Chi	urch (with add'l parking)
Existing building(s) square footage approx	18,800 sf	Proposed building(s	s) square footage none

Rev. December 2021

APPLICATION FEES:	
Apartment/townhouse	• \$550.00 + \$4.50/unit
Commercial/Industrial	• \$500.00 + \$50.00/acre
Institutional (Schools, Public Services, Hospitals)	• \$475.00 + \$40.00/acre
Mobile home park	• \$575.00 + \$5.00/unit
Planned Unit Development/Mixed use development	• \$550.00 + \$50.00/acre
Preliminary site plan review	75% of site plan review fee
Single family site condo (prelim or final)	• \$700.00 + \$5.00/lot
Site plan revision/review	75% of site plan review fee + any needed consulting fees determined by administration
Site plan requiring review by city engineer	all costs by owner/applicant via escrow
Special meetings with planner/engineer	all costs by owner/applicant via escrow
Escrow Fee (Consultant fees for planning, zoning)	• \$1,500
A cash deposit of \$1.500 shall be placed with the City of the control of the c	of Owosso
The City will let the applicants know when additional fur	nds are needed (typically when about 25% is remaining)
Should there be funds remaining in the account after co	ompletion of the project, the balance will be returned
not been provided, the appropriate box has been chec been provided.	the data contained on the site plan. If the required data has cked with a statement of explanation on why the data has not
forwarded to the Planning Commission for considerati	e, it may be returned by the City for revisions without being on, until the requirements have been adequately met.
 By signing this application, the applicant hereby grant representatives, and/or appointees to enter upon the examination. 	s full authority to the City of Owosso, its agents, employees, undersigned lands/parcels for the purposes of inspection and
7 M	
to Michael Brief	(-23-22
Signature of Applicant	Date
F. Michael Oku	6-23-22
Signature of Deed/Title Holder	Date


SITE PLAN REVIEW CHECKLIST:

Check the appropriate box. If item is marked as 'not provided', attach detailed explana	won.	Not Dravided
	Provided	Not Provided
1. Site location Map		
2. North arrow, scale – 1" equals 50' if the subject property is less than 3 acres	_ //	
and 1" equals 100' if 3 acres or more		
3. Revision dates		
Signature and Seal of Architect/Surveyor/Engineer		
5. Area of site (in acres and square feet)		
6. Boundary of the property outlined in solid line		
7. Names, centerline and right-of-way widths of adjacent streets		
8. Zoning designation of property	<u> </u>	
9. Zoning designation and use of adjacent properties		
10. Existing and proposed elevations for building(s), parking lot areas and drives	-	
11. Direction of surface water drainage and grading plan and any plans for storm		. 11-0-1-0-1
water retention/detention on site	*	
12. Required setbacks from property lines and adjacent parcels		
13. Location and height of existing structures on site and within 100' of the property		
14. Location and width of existing easements, alleys and drives	<u> </u>	
15. Location and width of all public sidewalks along the fronting street right-of-way	J	
and on the site, with details	•	
16. Layout of existing/proposed parking lot, with space and aisle dimensions	V	
17. Parking calculations per ordinance		
18. Location of all utilities, including but not limited to gas, water, sanitary sewer,		
electricity, telephone	V	
19. Soil erosion and sedimentation control measures during construction	<u> </u>	
20. Location and height of all exiting/proposed fences, screens, walls or other	I	
barriers	W	
21. Location and details of dumpster enclosure and trash removal plan	V	1

ST. PAUL'S CHURCH PARKING LOT

111 N. HOWELL STREET
CITY OF OWOSSO, SHIAWASEE COUNTY, MICHIGAN

PERMIT / APPROVAL SUMMARY					
DATE SUBMITTED	DATE APPROVED	PERMIT / APPROVAL			
6/23/2022		CITY OF OWOSSO			
		SHIAWASEE COUNTY SESC			

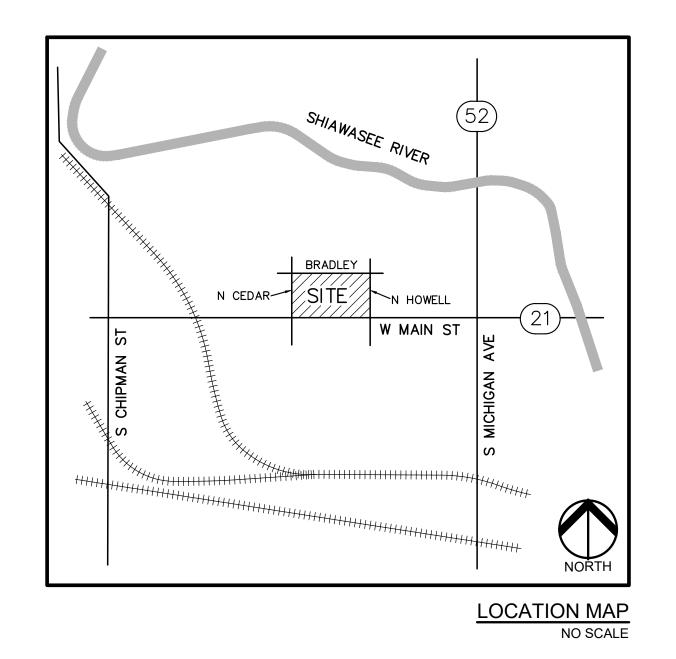

	INDEX OF DRAWINGS
NUMBER	TITLE
C-0.0	COVER SHEET
C-1.0	TOPOGRAPHIC SURVEY & DEMOLITION PLAN
C-2.0	DIMENSION & PAVING PLAN
C-3.0	GRADING & SOIL EROSION CONTROL PLAN
C-4.0	UTILITY PLAN
C-5.0	STORMWATER PLAN
C-6.0	STORM SEWER PROFILES
C-7.0	NOTES & DETAILS
C-7.1	DETAILS
C-7.2	DETAILS
SL-1.0	PHOTOMETRIC PLAN
L-1.0	LANDSCAPE PLAN
L-2.0	LANDSCAPE DETAILS

DESIGN TEAM


OWNER/APPLICANT/DEVELOPER CIVIL ENGINEER

ST PAUL'S CATHOLIC CHURCH 111 N. HOWELL ST OWOSSO, MI 48867 CONTACT: TERRY DUMOND PHONE: 989.277.2687 EMAIL: TDUMOND64@GMAIL.COM PEA GROUP
7927 NEMCO WAY, STE. 115
BRIGHTON, MI 48116
CONTACT: THOM DUMOND, PLA, LEED AP
PHONE: 844.813.2949
EMAIL: TDUMOND@PEAGROUP.COM

LANDSCAPE ARCHITECT

PEA GROUP
7927 NEMCO WAY, STE. 115
BRIGHTON, MI 48116
CONTACT: THOM DUMOND, PLA
PHONE: 844.813.2949
EMAIL: TDUMOND@PEAGROUP.COM



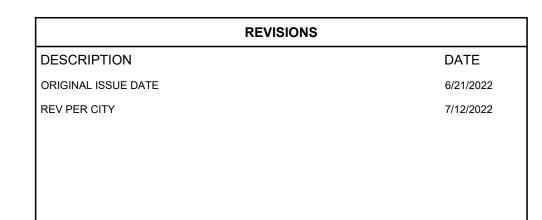




FLOODPLAIN NOTE: **BENCHMARKS**: LEGEND: BY GRAPHICAL PLOTTING, SITE IS WITHIN ZONE 'X', AREA (GPS DERIVED - NAD 27) DETERMINED TO BE OUTSIDE OF THE 0.2% ANNUAL CHANCE -OH-ELEC-VV-O- EX. OH. ELEC, POLE & GUY WIRE FLOODPLAIN PER FLOOD INSURANCE RATE MAP NUMBER 26155C0231C DATED SEPTEMBER 29, 2011. -UG-CATV-TV- EX. U.G. CABLE TV & PEDESTAL BENCH TIE ON THE SOUTH SIDE OF POWER POLE. LOCATED 20'± NORTH OF THE CENTERLINE OF BRADLEY ROAD AND 55'± EAST OF THE WEST ENTRANCE OF PARKING LOT ON THE -UG-ELEC-E-E-E-EX. U.G. ELEC, MANHOLE, METER & HANDHOLE NORTH SIDE OF BRADLEY STREET. — - — - — EX. GAS LINE ELEVATION: 739.40 © GAS EX. GAS VALVE & GAS LINE MARKER BM #301 BENCH TIE ON THE EAST SIDE OF A POWER POLE. LOCATED — — — EX. WATER MAIN 20'± WEST OF THE CENTERLINE OF N CEDAR STREET AND ∀ → W EX. HYDRANT, GATE VALVE & POST INDICATOR VALVE 100'± SOUTH OF THE CENTERLINE OF BRADLEY STREET. ELEVATION: 741.35 ----- EX. SANITARY SEWER BM #302 GEAR PIN ON THE NORTH SIDE OF POWER POLE. LOCATED EX. COMBINED SEWER MANHOLE 60'± EAST OF OWOSSO DONUTS SIGN AND 25'± SOUTH OF THE —— -- EX. STORM SEWER CENTERLINE OF M-21. _ ELEVATION: 739.51 RIM 738.21 SE 10" RCP - 736.06 NW 6" PVC -736.56 EX. SQUARE, ROUND, & BEEHIVE CATCH BASIN EX. YARD DRAIN & ROOF DRAIN EX. UNIDENTIFIED STRUCTURE W 12" RCP - 734.44 SAWCUT AND REMOVE ————— EX. FENCE SE 10" RCP - 735.64 E 12" RCP - 734.34 ASPHALT PAVEMENT, TYP. • • • EX. GUARD RAIL NW 10" RCP - 735.59 E 12" PVC - 729.84 W 12" PVC - 729.84 SAWCUT AND REMOVE W 12" RCP - 733.31 E 12" RCP - 733.31 BRADLEY STREET EX. SPOT ELEVATION CONCRETE CURB, TYP. N 12" RCP - 733.4 EX. CONTOUR EX. WETLAND RIM 738.02 NW 10" RCP - 735.92 SAWCUT AND REMOVE ASPHALT PAVEMENT, SAWCUT AND REMOVE

SAW OH-WIRES NAIL FOUND / NAIL & CAP SET **√**SAWCUT CONCRETE CURB, TYP. **BRASS PLUG SET** MONUMENT FOUND / SET RIM 738.30 SECTION CORNER FOUND R M C RECORDED / MEASURED / CALCULATED CAUTION!! SAWCUT CONC. WALK CAUTION!! < X39X X6 XX SAWCUT CONCRETE REFERENCE DRAWINGS -|SIDEWALK TO NEAREST| JOINT, TYP. WATER MAIN CITY OF OWOSSO - EMAIL DATED 2/22/2022 SANITARY SEWER STORM SEWER ELECTRIC TELEPHONE CITY OF OWOSSO - EMAIL DATED 2/22/2022 CITY OF OWOSSO - EMAIL DATED 2/22/2022 CITY OF OWOSSO - EMAIL DATED 2/22/2022 SAWCUT AND REMOVE REMOVE CHAIN LINK LANDSCAPE · ASPHALT NO EMAILS AS OF 5/23/2022 DAY STARR - EMAIL DATED 2/23/2022 FENCE, TYP. -CONCRETE SIDEWALK AND SAWCUT AND REMOVE DRIVE APRON, TYP. CONSUMERS - EMAIL DATED 2/23/2022 ASPHALT PAVEMENT, TYP LOT 1 LOT 11 **DEMOLITION LEGEND:** ITEM TO BE PROTECTED ITEM TO BE REMOVED CURB/FENCE REMOVAL . /././././././././. LOT 7 LOT 6 CONCRETE PAVEMENT AND SIDEWALK REMOVAL ABANDON UTILITY ••••• SAW CUT CURB REMOVE BLOCK PLANTER IN THIS ASPHALT REMOVAL HORIZONTALLY TO PROVIDE AREA. SALVAGE BRICKS FOR REUSE IN RECONFIGURING PLANTER ACCESS FOR DRIVE AFTER WALK CONSTRUCTION. TREE REMOVAL _{კვ}ა[©] LOT 12 LOT 2 SAWCUT LINE SAWCUT CONCRETE -SIDEWALK TO NEAREST JOINT, TYP. **GENERAL DEMOLITION NOTES:** THESE NOTES APPLY TO ALL CONSTRUCTION ACTIVITIES ON THIS PROJECT: REMOVE TREE, TYP. ALL MATERIAL TO BE REMOVED, WHETHER SPECIFICALLY NOTED IN THE PLANS OR NOT, SHALL BE REMOVED FROM THE SITE BY THE CONTRACTOR AND DISPOSED OF OFF-SITE IN A LEGAL MANNER. NO ON-SITE BURY OR BURN PITS SHALL BE BLOCK 13 . ALL DEMOLITION WORK SHALL CONFORM TO ALL LOCAL CODES AND ORDINANCES. STAGING/PHASING OF DEMOLITION AND CONSTRUCTION IS TO BE COORDINATED WITH THE OWNER AND THE CONTRACTOR PRIOR TO CONSTRUCTION. SPECIFIC DEMOLITION ITEMS HAVE BEEN INDICATED ON THE PLANS AS A GUIDE TO THE GENERAL SCOPE OF THE WORK. IT IS THE INTENT THAT THESE ITEMS SHALL BE COMPLETELY REMOVED BY THE CONTRACTOR ABOVE AND BELOW GROUND, UNLESS SPECIFICALLY NOTED OTHERWISE, AND THAT DEMOLITION WILL INCLUDE BUT WILL NOT NECESSARILY BE LIMITED TO THESE ITEMS. CONTRACTOR SHALL VISIT SITE TO VERIFY EXISTING CONDITIONS AND EXTENTS OF THE DEMOLITION THAT WILL BE REQUIRED PRIOR TO SUBMITTING A BID. REMOVE ALL STRUCTURES DESIGNATED FOR REMOVAL ACCORDING TO THE DEMOLITION PLAN. THIS INCLUDES FOUNDATIONS, FOOTINGS, FOUNDATION WALLS, FLOOR SLABS, UNDERGROUND UTILITIES, CONCRETE, ASPHALT, TREES, ETC. THE CONTRACTOR SHALL, AS A MINIMUM, PROVIDE TREE PROTECTION FENCING AROUND EXISTING TREES TO BE SAVED THAT ARE WITHIN 15 FEET OF CONSTRUCTION ACTIVITIES AND AS INDICATED IN THE PLANS OR PER LOCAL AGENCY REQUIREMENTS. LOT 14 LOT 9 LOT 4 THE CONTRACTOR SHALL BE RESPONSIBLE FOR CLEAN UP, NOISE, DUST CONTROL, STREET SWEEPING AND HOURS OF OPERATION IN ACCORDANCE WITH THE LOCAL CODES. THE CONTRACTOR SHALL PROVIDE ALL NECESSARY BARRICADES, SIGNAGE, MARKINGS, LIGHTS AND OTHER TRAFFIC CONTROL DEVICES TO PROTECT THE WORK ZONE AND SAFELY MAINTAIN TRAFFIC PER AGENCY REQUIREMENTS AND IN ACCORDANCE WITH THE LATEST EDITION OF THE STATE MANUAL OF UNIFORM TRAFFIC CONTROL DEVICES. THE CONTRACTOR SHALL CONTACT THE APPROPRIATE UTILITY COMPANIES TO CONFIRM THAT UTILITY LEADS HAVE BEEN TAKEN OUT OF SERVICE PRIOR TO METAL GRATED AREAS TO BE ALTERED, PROTECTED OR FILLED PER 10. ALL BUILDING GAS LEADS, METERS AND ASSOCIATED EQUIPMENT SHALL BE OWNER/ARCHITECT'S REMOVED AS SHOWN ON THE PLANS. COORDINATE ALL ASSOCIATED WORK WITH ABANDON GA DIRECTION THE APPROPRIATE UTILITY COMPANY. REMOVE ALL OVERHEAD AND UNDERGROUND ELECTRICAL LINES WITHIN THE AREA OF CONSTRUCTION AS SHOWN ON THE PLANS. COORDINATE SHUTDOWNS AND SAWCUT AND REMOVE REMOVALS WITH ELECTRICAL SERVICE PROVIDER OR THE APPROPRIATE UTILITY REMAINING CONCRETE COMPANY. (NOTE: PHONE AND CABLE T.V. SERVICES MAY ALSO BE LOCATED ON SIDEWALK, TYP. OVERHEAD LINES.) 2. THE CONTRACTOR IS RESPONSIBLE FOR THE REMOVAL AND REPLACEMENT OF SIGNS AND SUPPORTS WITHIN THE WORK AREA, AS NECESSARY TO FACILITATE CONSTRUCTION. SIGNS SHALL BE PROTECTED OR STOCKPILED FOR REUSE AS SPECIFIED IN THE PLANS OR AS REQUIRED BY THE AGENCY OF JURISDICTION. THE CONTRACTOR SHALL REPLACE ANY DAMAGED SIGNS AND SUPPORTS AT NO ADDITIONAL COST TO THE OWNER. | 10 | 12" STM | 13. THE CONTRACTOR SHALL NOTIFY THE APPROPRIATE 811/ONE CALL UTILITY LOCATING CENTER, THE CITY ENGINEER AND/OR THE AUTHORITY HAVING JURISDICTION 3 BUSINESS DAYS PRIOR TO THE BEGINNING OF CONSTRUCTION. W 8" PVC - 730.77 W. MAIN STREET (M-21) ASPHALT REMOVE BLOCK (85' PUBLIC R.O.W.) NOT FOR CONSTRUCTION

t: 844.813.2949 www.peagroup.com



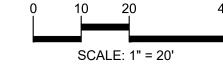



CAUTION!! THE LOCATIONS AND ELEVATIONS OF EXISTING UNDERGROUTILITIES AS SHOWN ON THIS DRAWING ARE ONLY OTILITIES AS SHOWN ON THIS DRAWING ARE UNLT APPROXIMATE. NO GUARANTEE IS EITHER EXPRESSED OR IMPLIED AS TO THE COMPLETENESS OR ACCURACY THEREOF. THE CONTRACTOR SHALL BE EXCLUSIVELY RESPONSIBLE FOR DETERMINING THE EXACT UTILITY LOCATIONS AND ELEVATIONS PRIOR TO THE START OF CONSTRUCTION.

CLIENT

ST PAUL CATHOLIC 111 N. HOWELL ST.

PROJECT TITLE

ST PAUL'S CHURCH **PARKING LOT** 111 N. HOWELL ST.


CITY OF OWOSSO, SHIAWASEE COUNTY, MICHIGAN

REVISIONS REV PER CITY

ORIGINAL ISSUE DATE: JUNE 23, 2022

DRAWING TITLE **TOPOGRAPHIC SURVEY & DEMOLITION PLAN**

PEA JOB NO. 2022-0249 DES. DRAWING NUMBER:

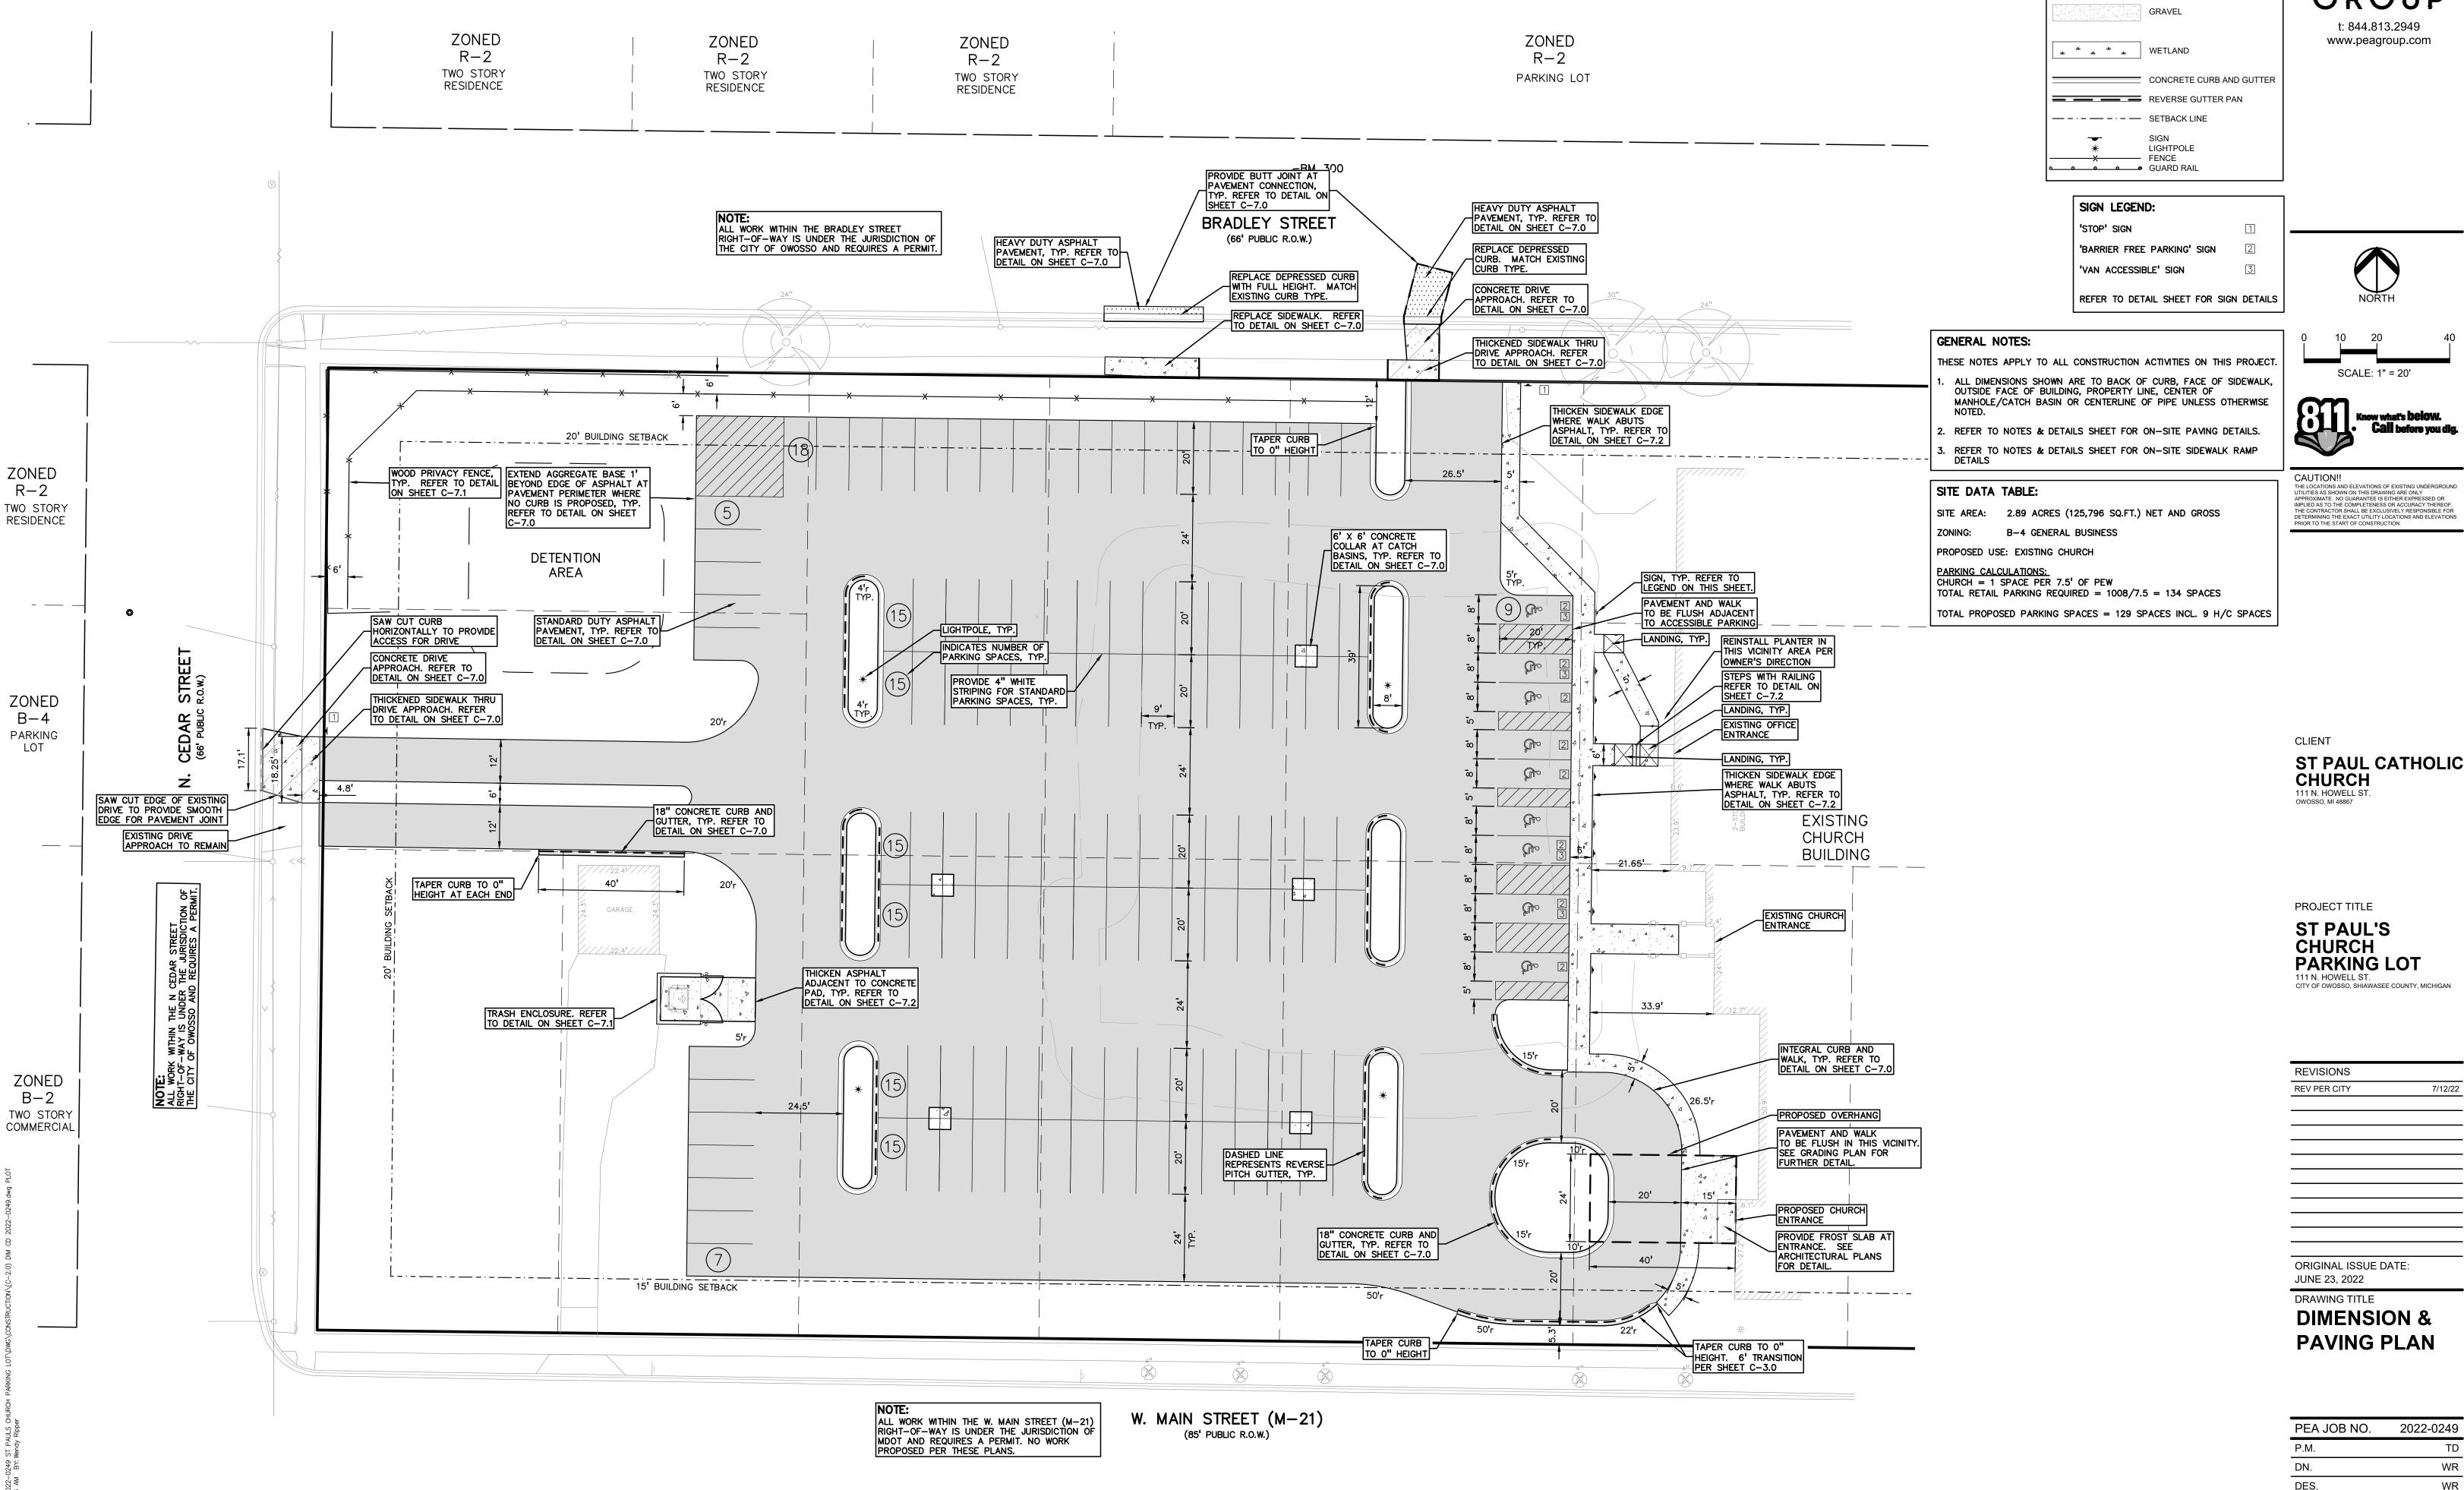

t: 844.813.2949 www.peagroup.com

LEGEND:

STD HEAVY DEEP DUTY DUTY STRENGTH

3TD HEAVY R.O.W. DUTY ONLY

ASPHALT PAVEMENT



ST PAUL CATHOLIC CHURCH 111 N. HOWELL ST. OWOSSO, MI 48867

PROJECT TITLE


ST PAUL'S CHURCH **PARKING LOT** 111 N. HOWELL ST.

REV PER CITY	7/12/22
ORIGINAL ISSUE DATE:	

JUNE 23, 2022 DRAWING TITLE

DIMENSION & PAVING PLAN

PEA JOB NO.	2022-0249
P.M.	TD
DN.	WR
DES.	WR
DRAWING NUMBER:	

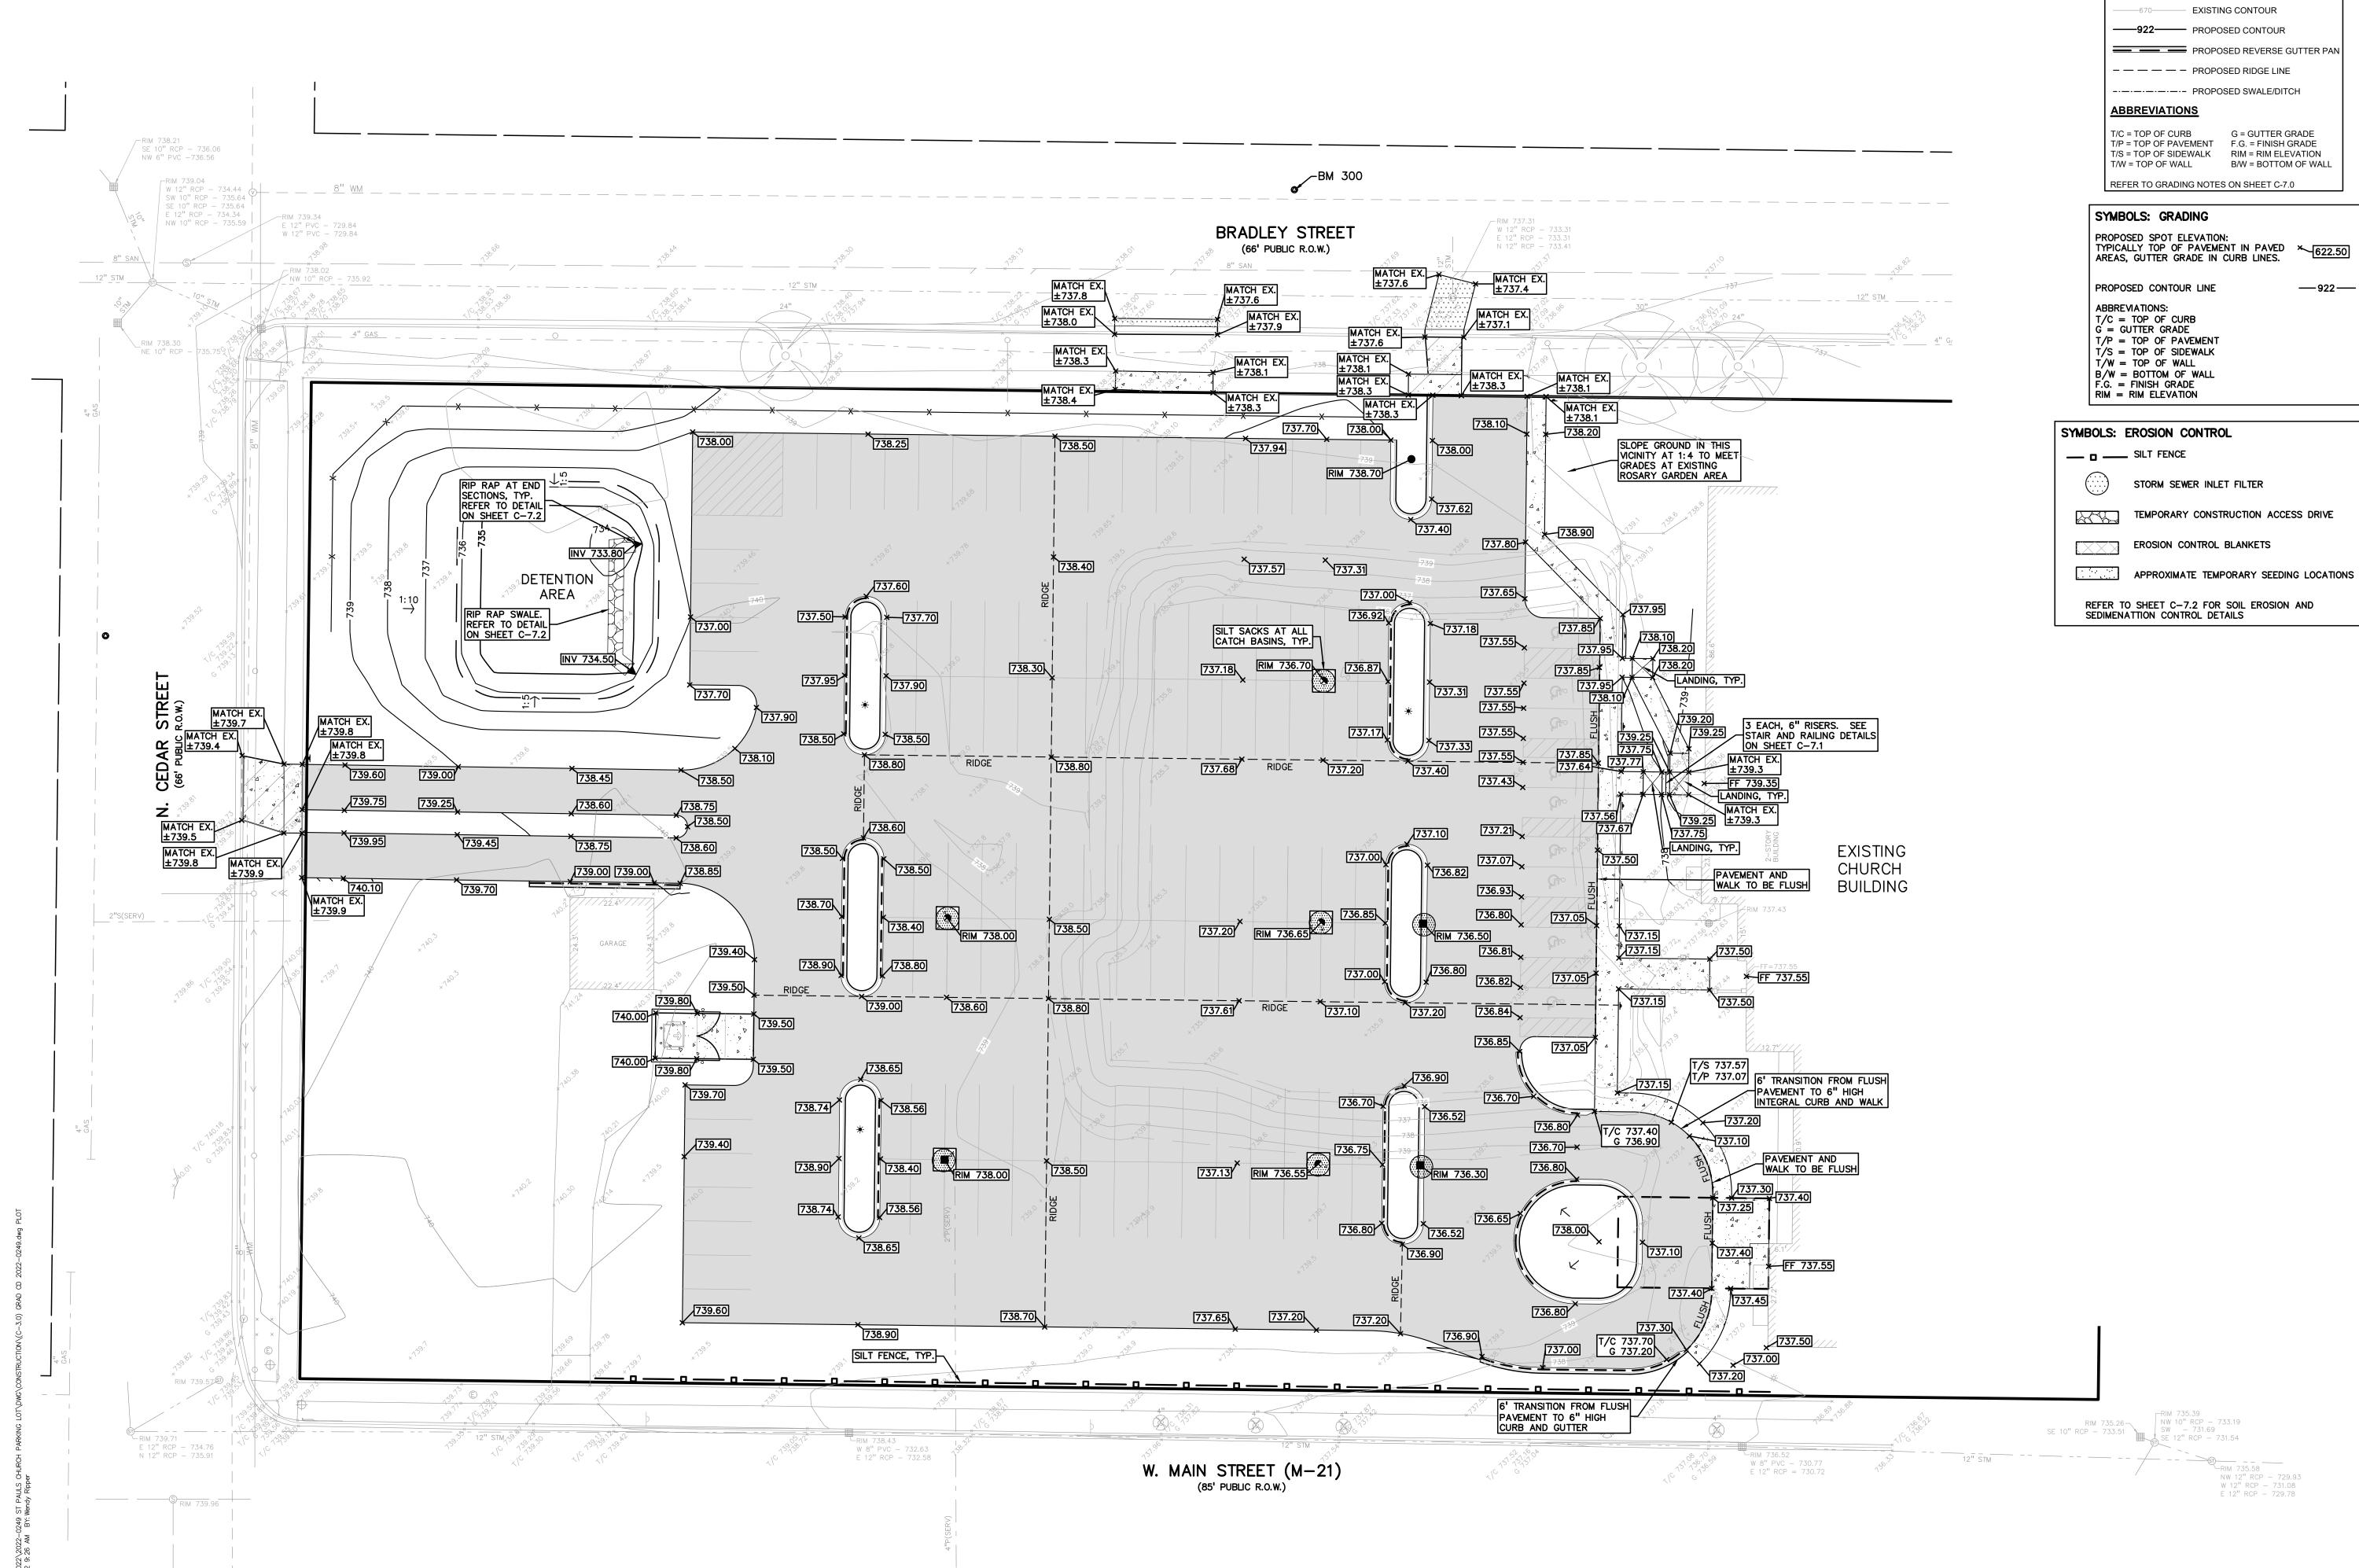

PEA GROUP t: 844.813.2949


www.peagroup.com


GRADING LEGEND:

EXISTING SPOT ELEVATION

IN CURB LINES.

PROPOSED SPOT ELEVATION: TYPICALLY TOP OF PAVEMENT IN PAVED AREAS, GUTTER GRADE

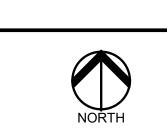

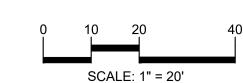



CAUTION!!

THE LOCATIONS AND ELEVATIONS OF EXISTING UNDERGROUND UTILITIES AS SHOWN ON THIS DRAWING ARE ONLY
APPROXIMATE. NO GUARANTEE IS EITHER EXPRESSED OR
IMPLIED AS TO THE COMPLETENESS OR ACCURACY THEREOF.
THE CONTRACTOR SHALL BE EXCLUSIVELY RESPONSIBLE FOR
DETERMINING THE EXACT UTILITY LOCATIONS AND ELEVATIONS
PRIOR TO THE START OF CONSTRUCTION.

CLIENT

ST PAUL CATHOLIC CHURCH 111 N. HOWELL ST. OWOSSO, MI 48867

PROJECT TITLE

ST PAUL'S
CHURCH
PARKING LOT

111 N. HOWELL ST.
CITY OF OWOSSO, SHIAWASEE COUNTY, MICHIGAN

REVISIONS
REV PER CITY 7/12/22

ORIGINAL ISSUE DATE:

DRAWING TITLE
GRADING &
SOIL EROSION
CONTROL PLAN


PEA JOB NO. 2022-0249

P.M. TD

DN. WR

DES. WR


DRAWING NUMBER:

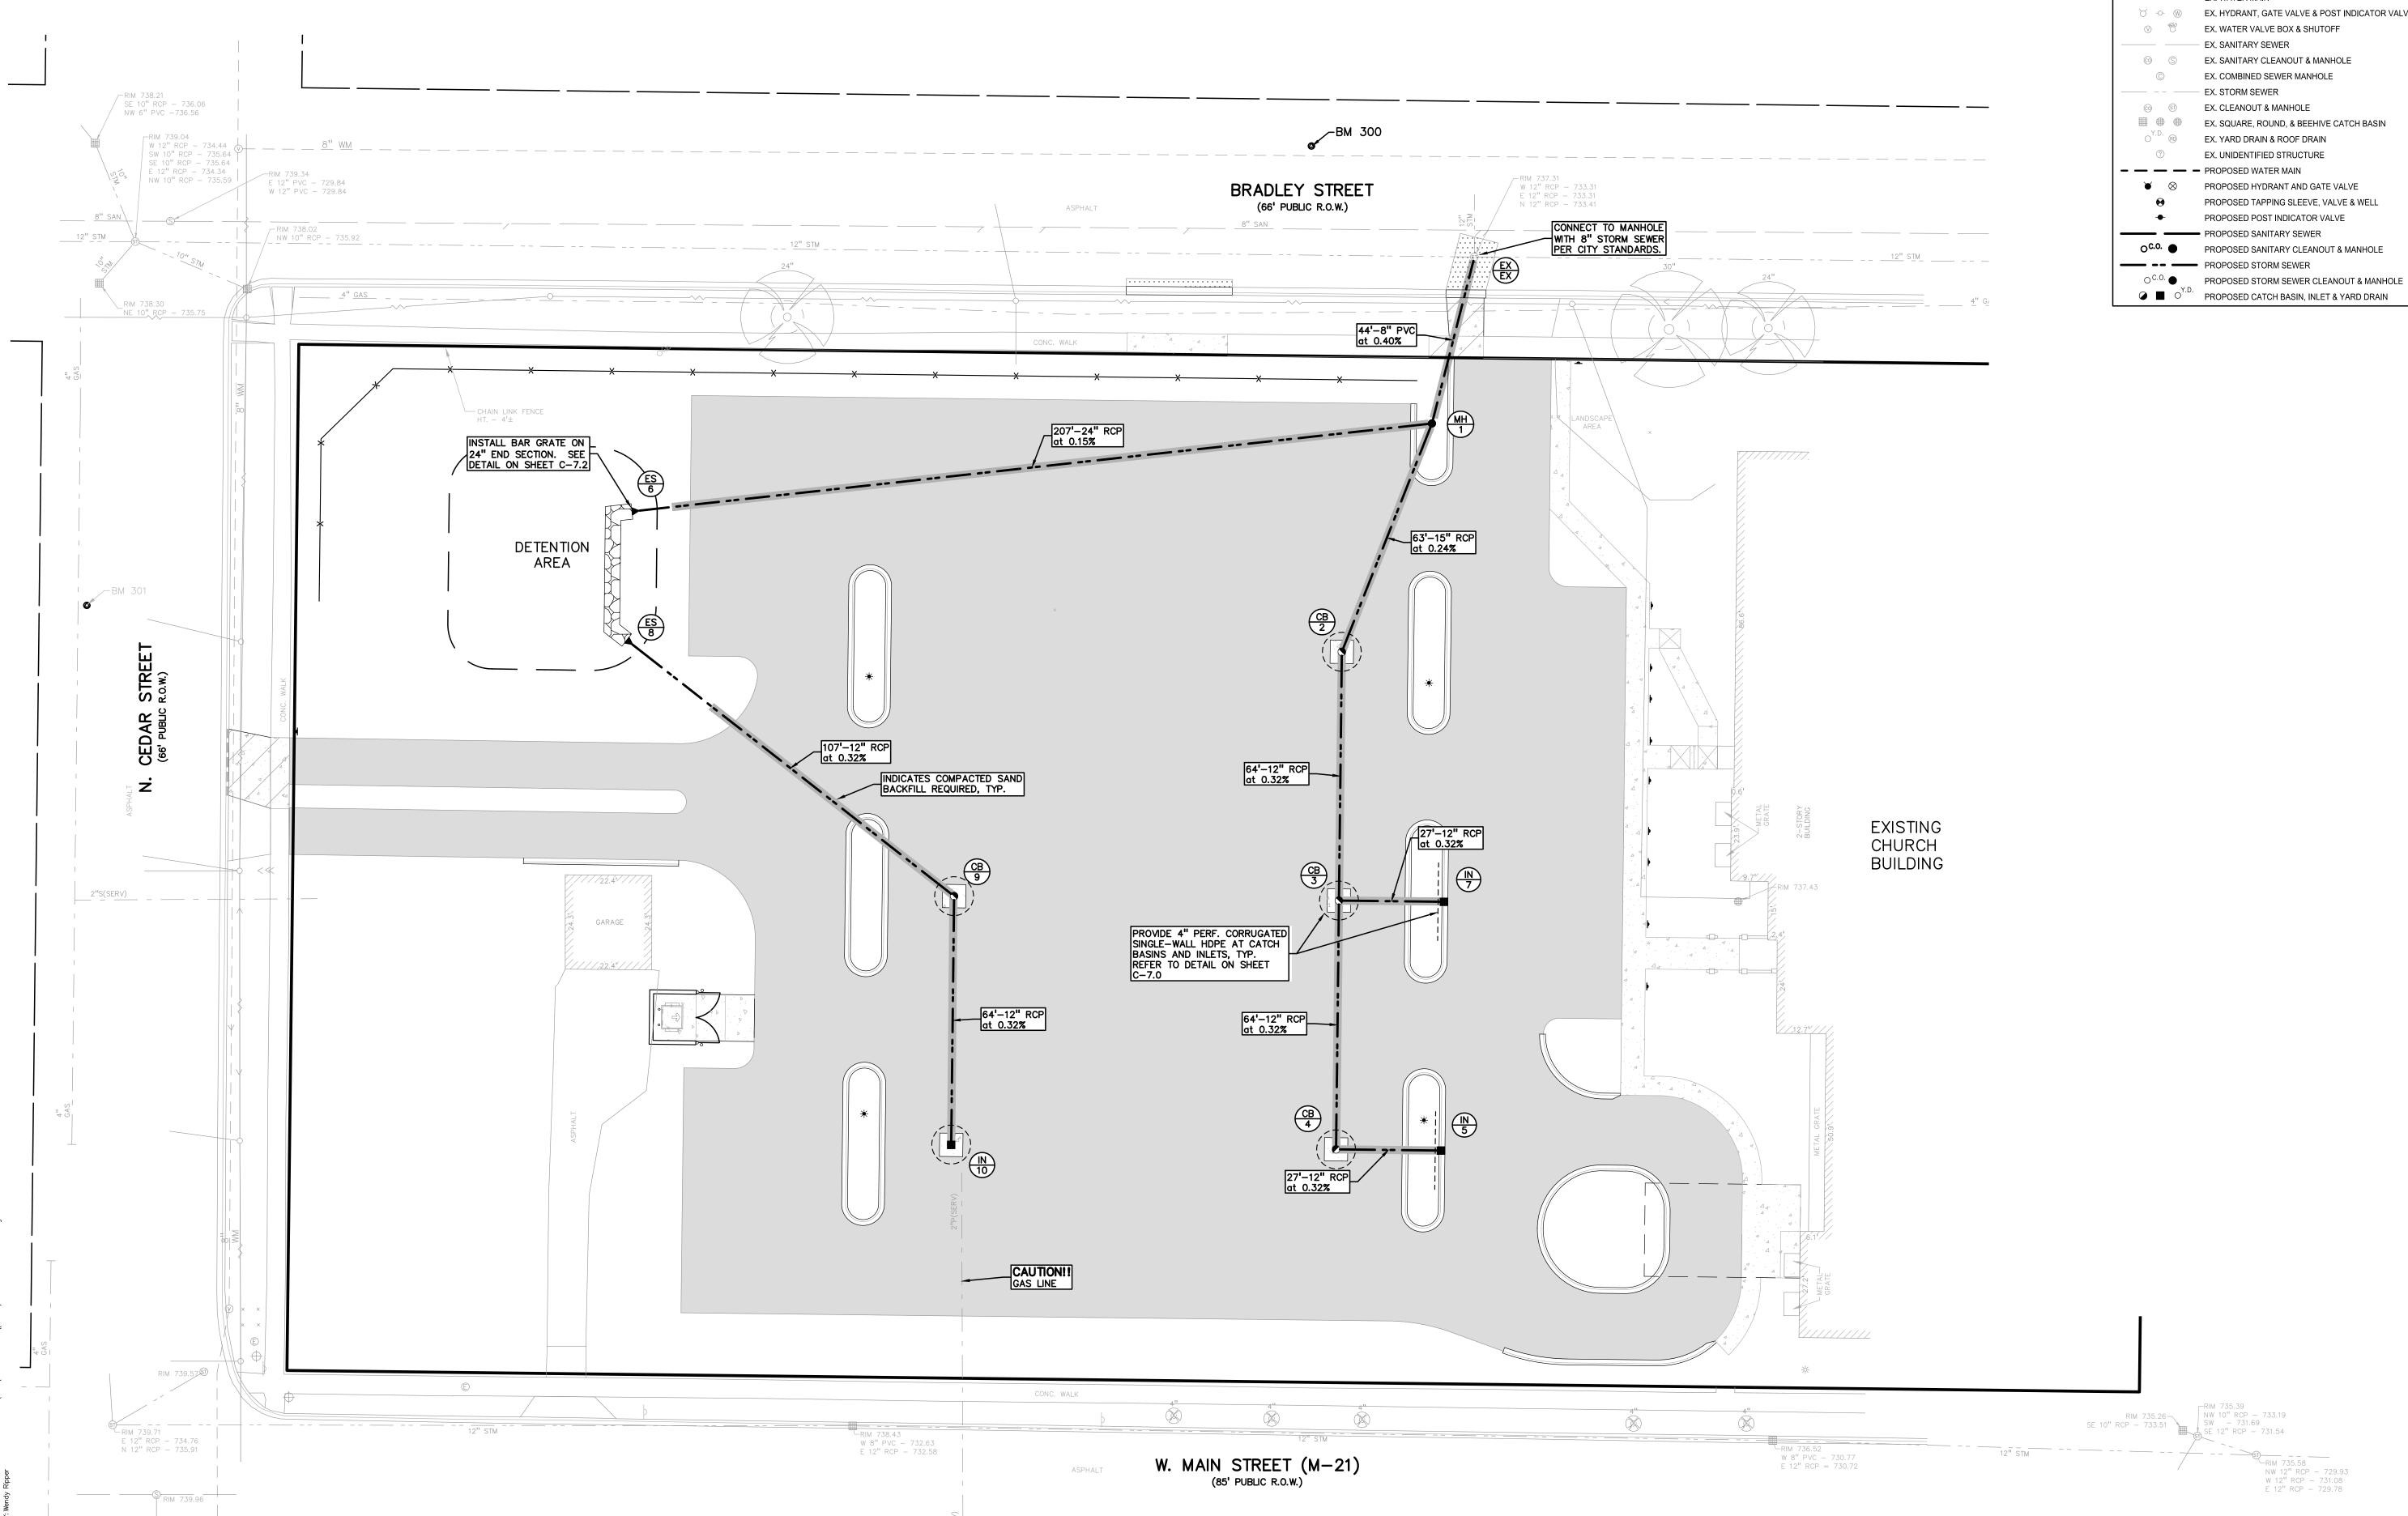

UTILITY LEGEND: -OH-ELEC-W-O- EX. OH. ELEC, POLE & GUY WIRE -UG-ELEC-E-E-EX. U.G. ELEC, MANHOLE, METER & HANDHOLE — – — – EX. GAS LINE © GAS EX. GAS VALVE & GAS LINE MARKER EX. WATER MAIN EX. HYDRANT, GATE VALVE & POST INDICATOR VALVE EX. WATER VALVE BOX & SHUTOFF EX. COMBINED SEWER MANHOLE EX. SQUARE, ROUND, & BEEHIVE CATCH BASIN O^{Y.D.} ® EX. YARD DRAIN & ROOF DRAIN EX. UNIDENTIFIED STRUCTURE ▼ ⊗ PROPOSED HYDRANT AND GATE VALVE PROPOSED TAPPING SLEEVE, VALVE & WELL PROPOSED POST INDICATOR VALVE





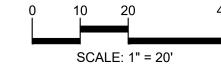



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CLIENT

ST PAUL CATHOLIC CHURCH 111 N. HOWELL ST. OWOSSO, MI 48867

PROJECT TITLE

ST PAUL'S
CHURCH
PARKING LOT


111 N. HOWELL ST.
CITY OF OWNSSO SHIAWASEE COUNTY M CITY OF OWOSSO, SHIAWASEE COUNTY, MICHIGAN

REVISIONS REV PER CITY

ORIGINAL ISSUE DATE: JUNE 23, 2022 DRAWING TITLE

UTILITY PLAN

	PEA JOB NO.	2022-0249
•	P.M.	TD
	DN.	WR
	DES.	WR
•	DRAWING NUMBER:	

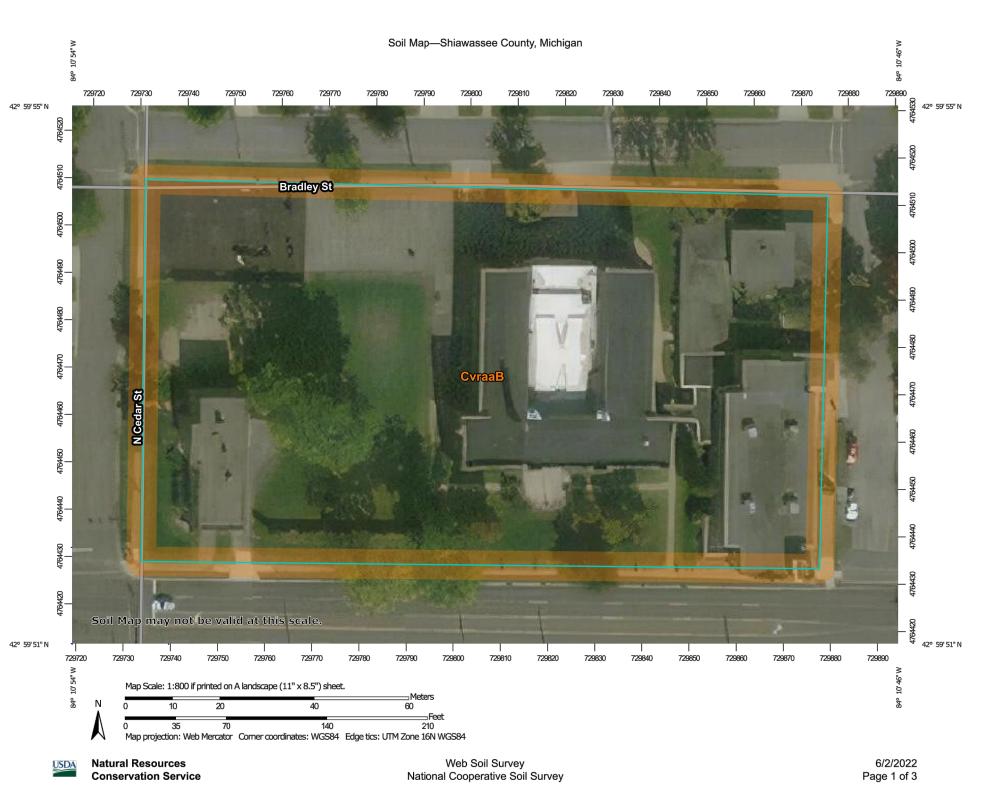

Map Unit Legend

Map Unit Symbol	Map Unit Name	Acres in AOI	Percent of AOI
CvraaB	Conover loam, 0 to 4 percent slopes	2.9	100.0%
Totals for Area of Interest		2.9	100.0%

DETENTION CALCULATIONS

IIIAW	ASSEE	COUNT	Y DETI	ENTION	POND	DESIGN	N CALC	ULATIO	N SPRE	ADSHEET
D	4 3 7	C4 D11- C	11- D1-	T 4	-)1 D	T		400/	(W)
		St Paul's C						erviousness:	42%	(K)
Project	Location:	City Of Ov	vosso, Sna	wasee Cou				f"C" Value:	0.49	(0)
		()	2.27	(T.)	IVIa			flow (CFS):	0.45	(G)
ont. Drai	nage Area	(Acres):	2.27	(L)		Storm Rec	currence in	erval (Yrs):	100	
A	В	С	D	Е	F	G	Н	I	J	
		100-Year	100-Year	Proposed	Proposed	Maximum	Required	Required	Total	
<u>.</u>	_	Total	Rainfall	Runoff	Runoff	Allowable	Detention	Forebay	Required	
Duration (Minutes)	Duration (Hours)	Rainfall (Inches)	Intensity (Inch/Hr)	Flowrate (CFS)	Volume (CFT)	Outflow (CFS)	Storage (CFT)	Storage (CFT)	Storage (CFT)	
5	0.08	0.62	7.44	8.34	2,503	0.45	2,435	4120.05	6,555	
10	0.08	1.09	6.54	7.33	4,400	0.45	4,264	4120.05	8,384	
15	0.17	1.40	5.60	6.28				4120.05		
20	0.23	1.40	4.89	5.48	5,652 6,580	0.45 0.45	5,447 6,308	4120.05	9,568 10,428	
30	0.50	1.03	3.84	4.31	7,751	0.45	7,342	4120.05	11,462	
40	0.50	2.19	3.84	3.68	8,841	0.45	8,296	4120.05	12,416	
50	0.83	2.19		3.19	-			4120.05	13,007	
60	1.00		2.84		9,568 9,850	0.45 0.45	8,887	4120.05		
		2.44	2.44	2.74	-		9,033		13,153	
90	1.50	2.84	1.89	2.12	11,465	0.45	10,239	4120.05	14,359	
120	2.00	3.02	1.51	1.69	12,192	0.45	10,557	4120.05	14,677	
180	3.00	3.33	1.11	1.24	13,443	0.45	10,992	4120.05	15,112	
360	6.00	3.90	0.65	0.73	15,744	0.45	10,841	4120.05	14,961	
720	12.00	4.52	0.38	0.42	18,247	0.45	8,441	4120.05	12,561	
1080	18.00	4.89	0.27	0.30	19,741	0.45	5,031	4120.05	9,151	
1440	24.00	5.20	0.22	0.24	20,992	0.45	1,379	4120.05	5,499	
			T	otal Stavaga	Detention of	nd Dotontion	Dominad St	orage (CFT):	15,112	
				otal Storage	Detention a	na Ketennon	Kequireusi	orage (CFI).	13,112	
PROP	OSED	CONDI	IION							
SHIAW	ASSEE	COUNT	TY DET	ENTION	POND	DESIGN	N CALC	ULATIO	N SPRE	ADSHEET
Droi	act Name:	St Paul's C	hurch Dark	ing I of		Droposed D	ercent Imp	erviousness:	59%	(K)
		City Of O						f "C" Value:	0.61	
Project	Location.	City Of O	wosso, Silla	iwasee Cot		·		flow (CFS):	0.45	(C)
				(L)	IVI			terval (Yrs):	100	(G)
						Stolli Red	currence in	tervar (118).	100	100000
	inage Area	(Acres):	2.27							
	inage Area	(Acres):	2.27 D	E	F	G	Н	I	J	
Cont. Dra	I				F Proposed	G Maximum	H Required	Required	J Total	
Cont. Dra	В	C 100-Year Total	D 100-Year Rainfall	E Proposed Runoff	Proposed Runoff	Maximum Allowable	Required Detention	Required Forebay	Total Required	
Cont. Dra A Duration	B	C 100-Year Total Rainfall	D 100-Year Rainfall Intensity	E Proposed Runoff Flowrate	Proposed Runoff Volume	Maximum Allowable Outflow	Required Detention Storage	Required Forebay Storage	Total Required Storage	
Cont. Dra A Duration (Minutes)	B Duration (Hours)	C 100-Year Total Rainfall (Inches)	D 100-Year Rainfall Intensity (Inch/Hr)	E Proposed Runoff Flowrate (CFS)	Proposed Runoff Volume (CFT)	Maximum Allowable Outflow (CFS)	Required Detention Storage (CFT)	Required Forebay Storage (CFT)	Total Required Storage (CFT)	
Cont. Dra A Duration (Minutes) 5	B Duration (Hours) 0.08	C 100-Year Total Rainfall (Inches)	D 100-Year Rainfall Intensity (Inch/Hr) 7.44	E Proposed Runoff Flowrate (CFS) 10.35	Proposed Runoff Volume (CFT) 3,106	Maximum Allowable Outflow (CFS) 0.45	Required Detention Storage (CFT) 3,038	Required Forebay Storage (CFT) 4120.05	Total Required Storage (CFT) 7,158	
Cont. Dra A Duration (Minutes) 5 10	B Duration (Hours) 0.08 0.17	C 100-Year Total Rainfall (Inches) 0.62 1.09	D 100-Year Rainfall Intensity (Inch/Hr) 7.44 6.54	E Proposed Runoff Flowrate (CFS) 10.35	Proposed Runoff Volume (CFT) 3,106 5,460	Maximum Allowable Outflow (CFS) 0.45	Required Detention Storage (CFT) 3,038 5,324	Required Forebay Storage (CFT) 4120.05	Total Required Storage (CFT) 7,158 9,444	
Cont. Dra A Duration (Minutes) 5 10 15	B Duration (Hours) 0.08 0.17 0.25	C 100-Year Total Rainfall (Inches) 0.62 1.09 1.40	D 100-Year Rainfall Intensity (Inch/Hr) 7.44 6.54 5.60	E Proposed Runoff Flowrate (CFS) 10.35 9.10 7.79	Proposed Runoff Volume (CFT) 3,106 5,460 7,013	Maximum Allowable Outflow (CFS) 0.45 0.45	Required Detention Storage (CFT) 3,038 5,324 6,809	Required Forebay Storage (CFT) 4120.05 4120.05	Total Required Storage (CFT) 7,158 9,444 10,929	
Cont. Dra A Duration (Minutes) 5 10	B Duration (Hours) 0.08 0.17	C 100-Year Total Rainfall (Inches) 0.62 1.09	D 100-Year Rainfall Intensity (Inch/Hr) 7.44 6.54	E Proposed Runoff Flowrate (CFS) 10.35	Proposed Runoff Volume (CFT) 3,106 5,460	Maximum Allowable Outflow (CFS) 0.45	Required Detention Storage (CFT) 3,038 5,324	Required Forebay Storage (CFT) 4120.05	Total Required Storage (CFT) 7,158 9,444	

30 0.50 1.92 3.84 5.34 9,618 0.45 9,210 4120.05 13,330

 40
 0.67
 2.19
 3.29
 4.57
 10,971
 0.45
 10,426
 4120.05
 14,546

 50
 0.83
 2.37
 2.84
 3.96
 11,872
 0.45
 11,191
 4120.05
 15,311

 60
 1.00
 2.44
 2.44
 3.40
 12,223
 0.45
 11,406
 4120.05
 15,526

 90
 1.50
 2.84
 1.89
 2.63
 14,227
 0.45
 13,001
 4120.05
 17,121

120 2.00 3.02 1.51 2.10 15,128 0.45 13,494 4120.05 17,614

 180
 3.00
 3.33
 1.11
 1.54
 16,681
 0.45
 14,230
 4120.05
 18,350

 360
 6.00
 3.90
 0.65
 0.90
 19,537
 0.45
 14,634
 4120.05
 18,754


 720
 12.00
 4.52
 0.38
 0.52
 22,643
 0.45
 12,836
 4120.05
 16,956

 1080
 18.00
 4.89
 0.27
 0.38
 24,496
 0.45
 9,787
 4120.05
 13,907

 1440
 24.00
 5.20
 0.22
 0.30
 26,049
 0.45
 6,436
 4120.05
 10,556

Total Storage Detention and Retention Required Storage (CFT): 18,754

		Acres		
Applied C Factors:		Greenspace: Pavement/Build	lings:	0.20 0.85
Existing Conditions	<u>3:</u>			
Greensp	ace		1.32	Acres
E F	us Areas: Buildings: Pavement: Total:		0.44	Acres Acres Acres
	Existing Site: % Impervious		0.47 42 %	
Shiawas	d Detention per ee County Por Speadsheet		15,112	CF
Proposed Condition	ns:			
Greensp	ace		0.92	Acres
E F T	us Areas: Buildings: Pavement: Total: Proposed Site	e:	1.34	Acres Acres Acres
	d % Impervious		59%	
Shiawas		nd ased on	18,754 3,642	
Detention Basin Vo	<u>olume</u>			
Contoui <u>Elevatio</u> i	Detention <u>Area</u>	Incremental <u>Volume</u>	Cumulative <u>Volume</u>	
HWL 736.3 736 735 734 Bottom 733.8	2,903 2,612 1,839 123	827 2,226 981 12	4,046 3,219 993 12	
Bottom 700.0				

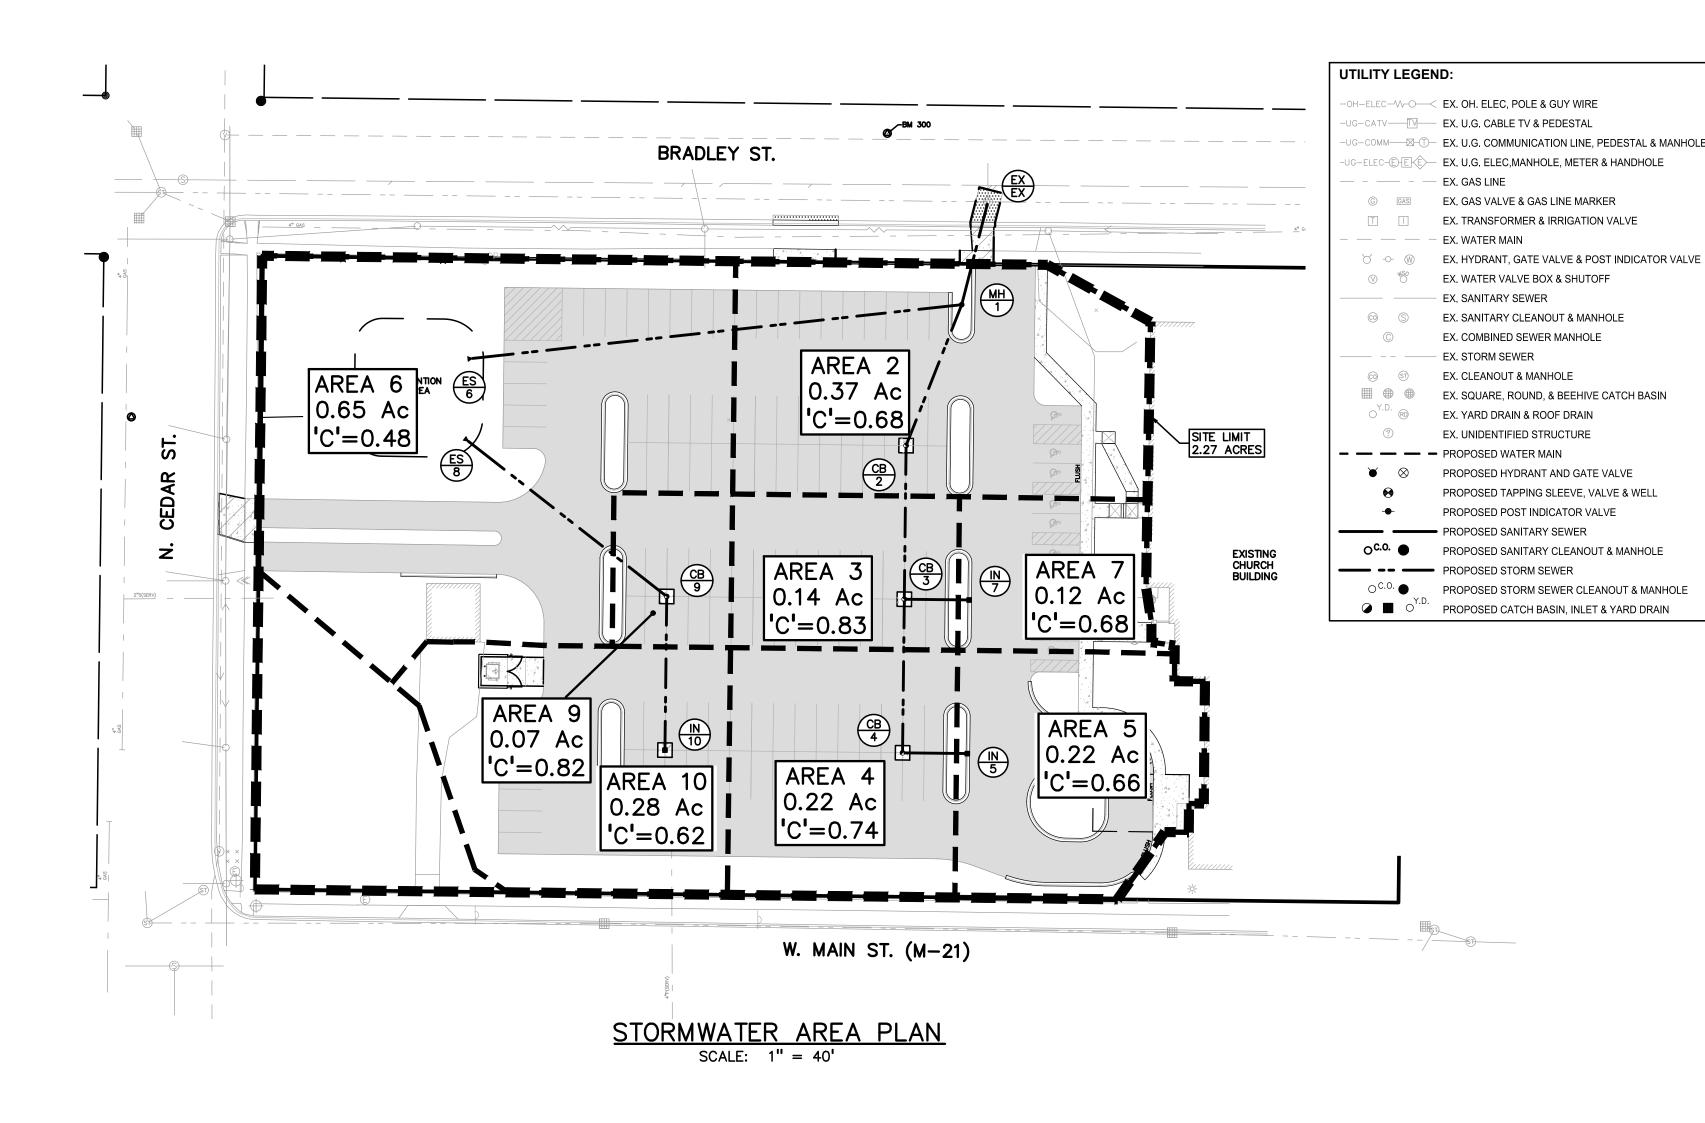

STORM SEWER CALCULATIONS

STORM SEWER SYSTEM DESIGN

STORM STRUCTURES

(6' DIA./0' SUMP) RIM = 738.70 15" S 733.49 24" W 733.49 8" N 733.49

(4' DIA./2' SUMP) RIM = 736.70 12" S 733.64

(4' DIA./2' SUMP) RIM = 736.65

15" N 733.64

12" E 733.84 12" N 733.84

(4' DIA./2' SUMP) RIM = 736.55 12" E 734.05

(2' DIA./2' SUMP) RIM = 736.30

12" N 734.05

12" W 734.14

24" E 733.80

12" W 733.93

12" SE 734.50

(4' DIA./2' SUMP) RIM = 738.00 12" S 734.84

12" NW 734.84

10 (2' DIA./2' SUMP) RIM = 738.00

12" N 735.05

(2' DIA./2' SUMP) RIM = 736.50

CB 3 12" S 733.84

EX EX RIM = 737.39

8" S 733.31

Location: Shiawasee County, City of Owosso I=3.04 in/hr based on MDOT, Zone 9, T=20 min.

T =	20	(min.)		Pipe "	n" Value =	=	0.013															
FROM	ТО	AREA	COEF.		TOTAL	TOTAL	TIME	INT.	FLOW	PIPE	PIPE	PIPE	PIPE	MIN HG	VEL.	TIME	H.G.L.	ELEV.	RIM E	ELEV.	INVER.	T ELEV.
STR	STR	(A) (Acres)		AxC	AREA (AxC)	AREA (Acres)	t (min.)	l (in/hr)	Q (cfs)	CAP. (cfs)	DIA. (in.)	LENGTH (ft.)	SLOPE (%)	PER "Q"	FULL (ft./sec)	FLOW (min.)	UP STREAM	DOWN STREAM	UP STREAM	DOWN STREAM	UP STREAM	DOWN STREAM
5	4	0.22	0.66	0.15	0.15	0.22	20.00	3.04	0.44	2.03	12	27	0.32	0.02%	2.6	0.2	734.94	734.85	736.30	736.55	734.14	734.05
4	3	0.22	0.74	0.17	0.31	0.44	20.20	3.04	0.95	2.00	12	64	0.32	0.07%	2.6	0.4	734.85	734.76	736.55	736.65	734.05	733.84
3	2	0.14	0.83	0.12	0.51	0.70	20.60	3.04	1.54	2.00	12	64	0.32	0.19%	2.6	0.4	734.76	734.64	736.65	736.70	733.84	733.64
2	1	0.37	0.68	0.25	0.76	1.07	21.00	3.04	2.31	3.16	15	63	0.24	0.13%	2.6	0.4	734.64	734.49	736.70	738.70	733.64	733.49
7	3	0.12	0.68	0.08	0.08	0.12	20.00	3.04	0.24	2.02	12	27	0.32	0.00%	2.6	0.2	734.73	734.64	736.50	736.65	733.93	733.84
6	1	0.65	0.48	0.31	0.31	0.65	20.00	3.04	1.66	8.70	24	207	0.15	0.01%	2.8	1.2	735.40	735.09	735.11	738.70	733.80	733.49
10	9	0.28	0.62	0.18	0.18	0.28	20.00	3.04	0.53	2.02	12	64	0.32	0.02%	2.6	0.4	735.84	735.64	738.00	738.00	735.04	734.84
9	8	0.07	0.82	0.06	0.23	0.36	20.40	3.04	0.71	2.02	12	107	0.32	0.04%	2.6	0.7	735.64	735.30	738.00	735.15	734.84	734.50

STORM SEWER FRAME & COVER NOTES

CATCH BASIN/INLET IN CURB
EJIW #7045 WITH M1 GRATE & 7050 T1 BACK


CATCH BASIN/INLET IN PAVED AREA
EJIW #1040 WITH TYPE M1 GRATE

CATCH BASIN/INLET IN GRASS AREAS
EJIW #1040 WITH TYPE N GRATE

MANHOLE
EJIW #1040 WITH TYPE B VENTED COVER

PEA GROUP t: 844.813.2949 www.peagroup.com



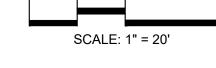



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ST PAUL CATHOLIC CHURCH
111 N. HOWELL ST.

PROJECT TITLE

ST PAUL'S
CHURCH
PARKING LOT

111 N. HOWELL ST.
CITY OF OWOSSO, SHIAWASEE COUNTY, MICHIGAN

REVISIONS

REV PER CITY 7/12/22


ORIGINAL ISSUE DATE:
JUNE 23, 2022

DRAWING TITLE

STORMWATER PLAN

PEA JOB NO. 2022-0249
P.M. TD
DN. WR
DES. WR
DRAWING NUMBER:

C-5.0

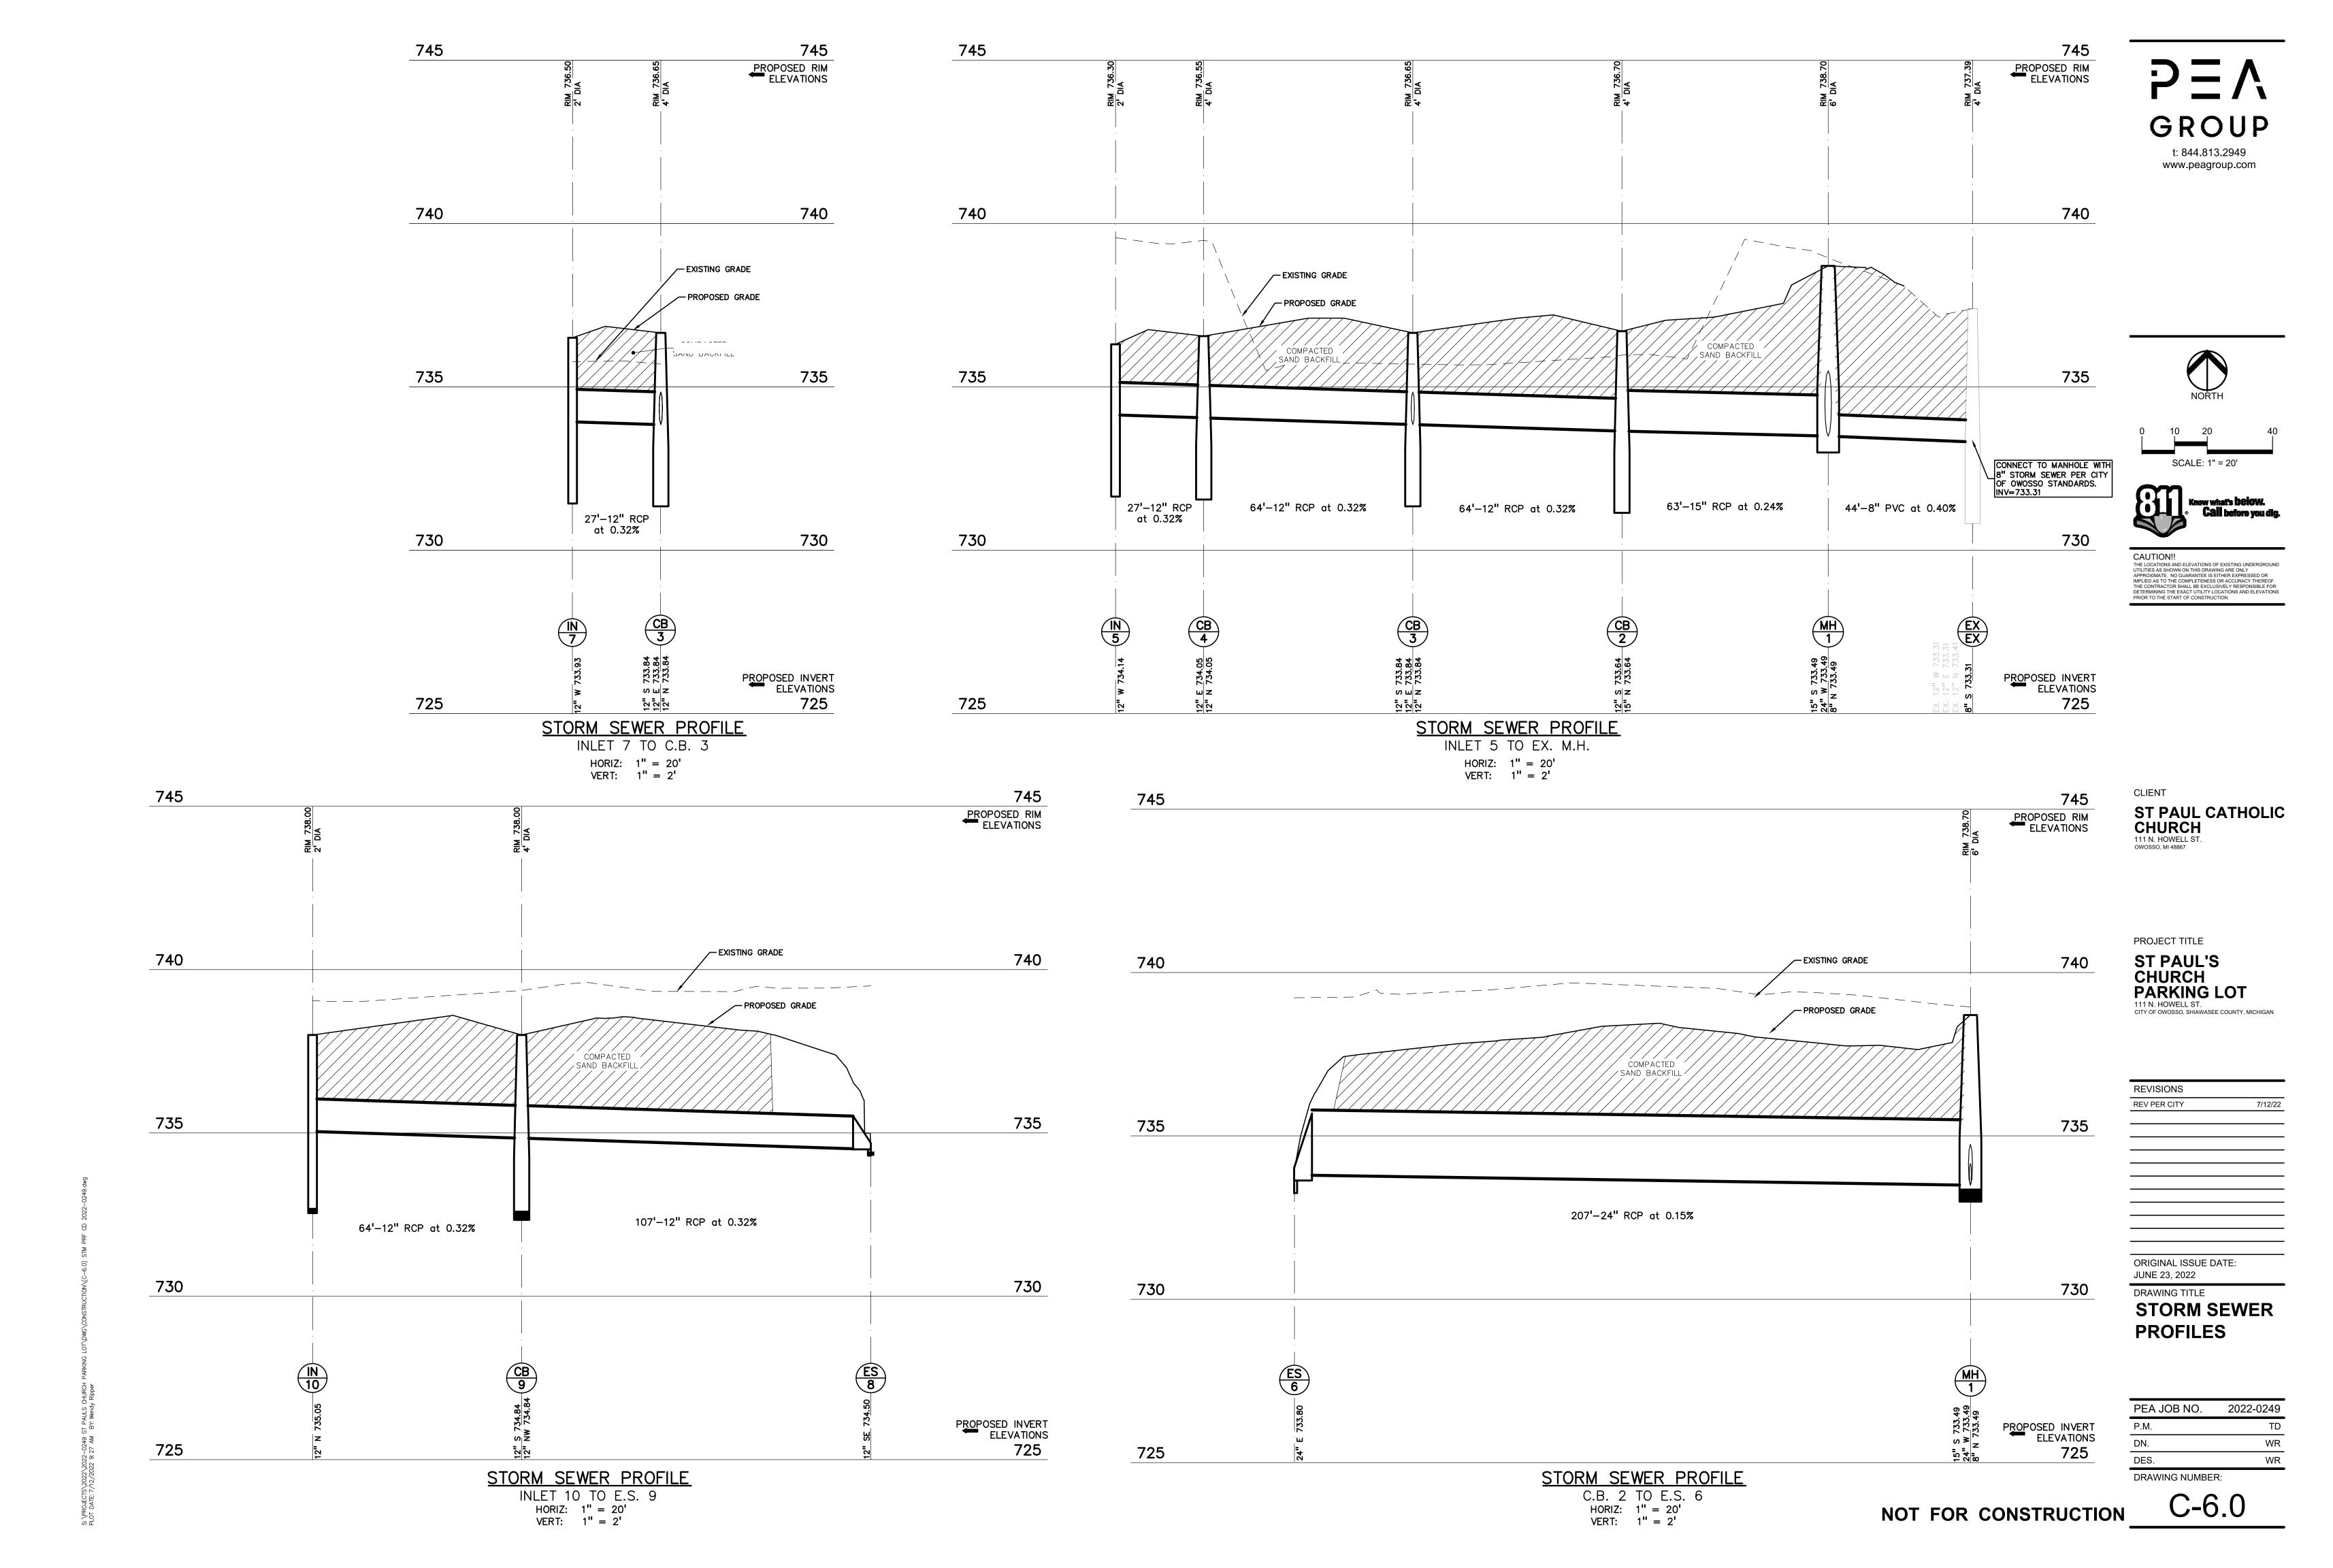

GENERAL NOTES:

- THESE NOTES APPLY TO ALL CONSTRUCTION ACTIVITIES ON THIS PROJECT
- ALL CONSTRUCTION, WORKMANSHIP AND MATERIALS SHALL BE IN ACCORDANCE WITH CURRENT OSHA, MDOT AND MUNICIPALITY STANDARDS AND REGULATIONS.
- THE CONTRACTOR SHALL NOTIFY THE CITY ENGINEER AND/OR THE AUTHORITY HAVING JURISDICTION 3 BUSINESS DAYS PRIOR TO THE BEGINNING OF CONSTRUCTION.
- THE CONTRACTOR SHALL CONTACT THE ENGINEER SHOULD THEY ENCOUNTER ANY DESIGN ISSUES DURING CONSTRUCTION. IF THE CONTRACTOR MAKES DESIGN MODIFICATIONS WITHOUT THE WRITTEN DIRECTION OF THE DESIGN ENGINEER, THE CONTRACTOR DOES SO
- ALL NECESSARY PERMITS, TESTING, BONDS AND INSURANCES ETC., SHALL BE PAID FOR BY THE CONTRACTOR. THE OWNER SHALL PAY FOR ALL CITY INSPECTION FEES.
- THE CONTRACTOR SHALL NOTIFY THE APPROPRIATE 811/ONE CALL UTILITY LOCATING CENTER, THE CITY ENGINEER AND/OR THE AUTHORITY HAVING JURISDICTION 3 BUSINESS DAYS PRIOR TO THE BEGINNING OF CONSTRUCTION. IF NO NOTIFICATION IS GIVEN AND DAMAGE RESULTS, SAID DAMAGE WILL BE REPAIRED AT SOLE EXPENSE OF THE CONTRACTOR. IF EXISTING UTILITY LINES ARE ENCOUNTERED THAT CONFLICT IN LOCATION WITH NEW CONSTRUCTION, THE CONTRACTOR SHALL NOTIFY THE DESIGN ENGINEER SO THAT THE CONFLICT MAY BE RESOLVED.
- CONTRACTOR SHALL VERIFY THAT THE PLANS AND SPECIFICATIONS ARE THE VERY LATEST PLANS AND SPECIFICATIONS AND FURTHERMORE, VERIFY THAT THESE PLANS AND SPECIFICATIONS HAVE BEEN APPROVED. ALL ITEMS CONSTRUCTED BY THE CONTRACTOR PRIOR TO RECEIVING FINAL APPROVAL, HAVING TO BE ADJUSTED OR RE—DONE, SHALL BE AT THE CONTRACTORS EXPENSE. SHOULD THE CONTRACTOR ENCOUNTER A CONFLICT BETWEEN THESE PLANS AND/OR SPECIFICATIONS, THEY SHALL SEEK CLARIFICATION IN WRITING FROM THE ENGINEER BEFORE COMMENCEMENT OF CONSTRUCTION. FAILURE TO DO SO SHALL BE AT SOLE
- ANY WORK WITHIN THE STREET OR HIGHWAY RIGHTS-OF-WAY SHALL BE PERFORMED IN ACCORDANCE WITH THE REQUIREMENTS OF THE AGENCIES HAVING JURISDICTION AND SHALL NOT BEGIN UNTIL ALL NECESSARY PERMITS HAVE BEEN ISSUED FOR THE WORK.
- ALL PROPERTIES OR FACILITIES IN THE SURROUNDING AREAS, PUBLIC OR PRIVATE, DESTROYED OR OTHERWISE DISTURBED DUE TO CONSTRUCTION, SHALL BE REPLACED AND/OR RESTORED TO THE ORIGINAL CONDITION BY THE CONTRACTOR.
- THE CONTRACTOR SHALL PROVIDE ALL NECESSARY BARRICADING, SIGNAGE, LIGHTS AND TRAFFIC CONTROL DEVICES TO PROTECT THE WORK AND SAFELY MAINTAIN TRAFFIC IN ACCORDANCE WITH LOCAL REQUIREMENTS AND THE MANUAL OF UNIFORM TRAFFIC CONTROL DEVICES (LATEST EDITION). THE DESIGN ENGINEER. OWNER, CITY AND STATE SHALL NOT BE HELD LIABLE FOR ANY CLAIMS RESULTING FROM ACCIDENTS OR DAMAGES CAUSED BY THE CONTRACTOR'S FAILURE TO COMPLY WITH TRAFFIC AND PUBLIC SAFETY REGULATIONS DURING THE CONSTRUCTION PERIOD.
- IO. THE USE OF CRUSHED CONCRETE IS PROHIBITED ON THE PROJECT WITHIN 100 FEET OF ANY WATER COURSE (STREAM, RIVER, COUNTY DRAIN, ETC.) AND LAKE, REGARDLESS OF THE APPLICATION OR LOCATION OF THE WATER COURSE OR LAKE RELATIVE TO THE
- II. IT SHALL BE THE RESPONSIBILITY OF THE CONTRACTOR TO ADJUST THE TOP OF ALL EXISTING AND PROPOSED STRUCTURES (MANHOLES, CATCH BASINS, INLETS, GATE WELLS ETC.) WITHIN GRADED AND /OR PAVED AREAS TO FINAL GRADE SHOWN ON THE PLANS. ALL SUCH ADJUSTMENTS SHALL BE INCIDENTAL TO THE JOB AND WILL NOT BE PAID FOR SEPARATELY.

PAVING NOTES:

- IN AREAS WHERE NEW PAVEMENTS ARE BEING CONSTRUCTED, THE TOPSOIL AND SOIL CONTAINING ORGANIC MATTER SHALL BE REMOVED PRIOR TO PAVEMENT CONSTRUCTION.
- REFER TO ARCHITECTURAL PLANS FOR DETAILS OF FROST SLAB AT EXTERIOR BUILDING DOORS.
- CONSTRUCTION TRAFFIC SHOULD BE MINIMIZED ON THE NEW PAVEMENT. IF CONSTRUCTION TRAFFIC IS ANTICIPATED ON THE PAVEMENT STRUCTURE, THE INITIAL LIFT THICKNESS COULD BE INCREASED AND PLACEMENT OF THE FINAL LIFT COULD BE DELAYED UNTIL THE MAJORITY OF THE CONSTRUCTION ACTIVITIES HAVE BEEN COMPLETED. THIS ACTION WILL ALLOW REPAIR OF LOCALIZED FAILURE, IF ANY DOES OCCUR, AS WELL AS REDUCE LOAD DAMAGE ON THE PAVEMENT SYSTEM.
- ALL EXPANSION JOINTS AND CONCRETE PAVEMENT JOINTS TO BE SEALED.
- CONCRETE PAVEMENT JOINTING UNLESS SHOWN OTHERWISE IN THE PLANS OR REQUIRED BY THE AUTHORITY HAVING JURISDICTION; 5.1. WHERE PROPOSED CONCRETE ABUTS A STRUCTURE, PROVIDE A MINIMUM 1/2" EXPANSION JOINT. THE JOINT FILLER BOARD MUST
- BE AT LEAST THE FULL DEPTH OF THE CONCRETE AND HELD DOWN A 1/2" TO ALLOW FOR SEALING. 5.2. WHERE PROPOSED CONCRETE ABUTS EXISTING CONCRETE OR IN BETWEEN POURS OF PROPOSED CONCRETE (CONSTRUCTION JOINT), PROVIDE 5/8" DOWELS EVERY 30" CENTER TO CENTER HALF WAY ALONG THE THICKNESS OF THE PROPOSED PAVEMENT. ALTERNATE DOWELS SIZES AND SPACING MUST BE APPROVED THE ENGINEER PRIOR TO COMMENCING WORK AND VIA THE
- WHERE PROPOSED CONCRETE ABUTS EXISTING OR PROPOSED SIDEWALK OR CURBING, PROVIDE A MINIMUM 1/2" EXPANSION JOINT. 5.4. CONTROL, LONGITUDINAL AND/OR TRANSVERSE JOINTS SHALL BE PLACED TO PROVIDE PANELS WITHIN THE PAVEMENT AS SQUARE AS POSSIBLE WITH THE FOLLOWING MAXIMUM SPACING PARAMETERS:
- 5.4.1. 6-INCH THICK CONCRETE PAVEMENT: 12' X 12' 5.4.2. 8-INCH THICK CONCRETE PAVEMENT: 15' X 15'
- 5.5. IRREGULAR-SHAPED PANELS MAY REQUIRE THE USE OF REINFORCING MESH OR FIBER MESH AS DETERMINED BY THE ENGINEER. THE USE OF MESH MUST BE APPROVED THE ENGINEER PRIOR TO COMMENCING WORK AND VIA THE SUBMITTAL PROCESS.
- 5.6. IF A JOINT PLAN IS NOT PROVIDED IN THE PLANS, THE CONTRACTOR SHALL SUBMIT ONE TO THE ENGINEER FOR REVIEW PRIOR TO COMMENCING WORK AND VIA THE SUBMITTAL PROCESS.
- CONCRETE CURBING JOINTING UNLESS SHOWN OTHERWISE IN THE PLANS OR REQUIRED BY THE AUTHORITY HAVING JURISDICTION 6.1. JOINTS WHEN ADJACENT TO ASPHALT PAVEMENT
- 6.1.1. PLACE CONTRACTION JOINTS AT 10' INTERVALS
- 6.1.2. PLACE 1/2" EXPANSION JOINT AT CATCH BASINS, EXISTING AND PROPOSED SIDEWALK OR EXISTING CURBING
- 6.1.3. PLACE 1" EXPANSION JOINT:
- 6.1.3.1. AT SPRING POINTS OF INTERSECTIONS OR ONE OF THE END OF RADIUS LOCATIONS IN A CURVE 6.1.3.2. AT 400' MAXIMUM INTERVALS ON STRAIGHT RUNS
- 6.1.3.3. AT THE END OF RADIUS AT OPPOSITE ENDS IN A CURBED LANDSCAPE ISLAND
- 6.2. JOINTS WHEN TIED TO CONCRETE PAVEMENT 6.2.1. PLACE CONTRACTION JOINTS OPPOSITE ALL TRANSVERSE CONTRACTION JOINTS IN PAVEMENT
- 6.2.2. PLACE 1/2" EXPANSION JOINT AT CATCH BASINS, EXISTING AND PROPOSED SIDEWALK OR EXISTING CURBING. 6.2.3. PLACE 1"EXPANSION JOINT OPPOSITE ALL TRANSVERSE EXPANSION JOINTS IN PAVEMENT
- 6.2.4. CURB AND GUTTER AND CONCRETE SHALL BE TIED TOGETHER SIMILAR TO A LONGITUDINAL LANE TIE JOINT (MDOT B1 JOINT)
- 6.3. IN BETWEEN POURS OF PROPOSED CONCRETE CURBING (CONSTRUCTION JOINT): 6.3.1. CARRY THE REBAR CONTINUOUSLY BETWEEN POURS
- 6.3.2. IF THE REBAR IS NOT LONG ENOUGH TO CARRY CONTINUOUSLY, THEN TIE TWO PIECES OF REBAR PER THE LATEST MDOT SPECIFICATIONS
- CONCRETE SIDEWALK JOINTING UNLESS SHOWN OTHERWISE IN THE PLANS OR REQUIRED BY THE AUTHORITY HAVING JURISDICTION 7.1. PLACE TRANSVERSE CONTRACTION JOINTS EQUAL TO THE WIDTH OF THE WALK WHEN WIDTH IS LESS THAN 8'
- 7.2. PLACE TRANSVERSE AND LONGITUDINAL CONTRACTION JOINTS EQUAL TO 1/2 THE WIDTH OF THE WALK WHEN WIDTH IS EQUAL TO OR GREATER THAN 8'
- PLACE 1" EXPANSION JOINT WHERE ABUTTING SIDEWALK RAMP AND/OR RADIUS IN INTERSECTION 7.4. PLACE TRANSVERSE 1/2" EXPANSION JOINT AT MAXIMUM OF 100' SPACING

PAVEMENT SHALL BE COMPLETELY EXCAVATED AND BACKFILLED WITH SUITABLE MATERIAL.

7.5. PLACE 1/2" EXPANSION JOINT WHEN ABUTTING A FIXED STRUCTURE, OTHER PAVEMENT (CONCRETE PAVEMENT AND DRIVE APPROACHES), UTILITY STRUCTURES, LIGHT POLE BASES AND COLUMNS

GENERAL GRADING AND EARTHWORK NOTES:

THESE NOTES APPLY TO ALL CONSTRUCTION ACTIVITIES ON THIS PROJECT

- CONTRACTOR SHALL FIELD VERIFY ALL EXISTING TREES AND BRUSH AND REMOVE ALL THAT ARE NECESSARY TO GRADE SITE.
- ALL GRADES ARE TO TOP OF PAVEMENT UNLESS OTHERWISE NOTED
- THE STAGING OF CONSTRUCTION ACTIVITIES SHALL OCCUR ONLY WITHIN THE SITE BOUNDARIES. ANY CONSTRUCTION ACTIVITIES OUTSIDE OF THE SITE BOUNDARIES SHALL BE AT THE SOLE RESPONSIBILITY AND RISK OF THE CONTRACTOR.
- ALL SOIL EROSION AND SEDIMENTATION CONTROL MEASURES SHALL MEET THE REQUIREMENTS OF THE AUTHORIZED PUBLIC AGENCY OF JURISDICTION. AN EROSION CONTROL PERMIT MUST BE SECURED FROM THE COUNTY PRIOR TO CONSTRUCTION.
- 5. ALL EARTHWORK AND GRADING OPERATIONS SHALL BE PERFORMED IN ACCORDANCE WITH THE SOILS INVESTIGATION AND REPORT.
- REFER TO SOIL EROSION CONTROL PLAN FOR ADDITIONAL SOIL EROSION AND SEDIMENTATION CONTROL MEASURES AND NOTES.
- THE DETENTION BASIN SIDE SLOPES AND ALL SLOPE EXCEEDING 1:6 MUST BE STABILIZED BY SODDING OR BY PLACING A MULCH BLANKET PEGGED IN PLACE OVER SEED.
- ALL DISTURBED AREAS SHALL BE SEEDED AND MULCHED OR SODDED IN ACCORDANCE WITH THE LANDSCAPE PLANS. PROVIDE A
- MINIMUM OF 3" OF TOPSOIL IN THESE AREAS UNLESS OTHERWISE NOTED. THE CONTRACTOR SHALL NOTE EXISTING UNDERGROUND UTILITIES WITHIN AND ADJACENT TO THE SITE. BACKFILL FOR EXISTING UTILITY TRENCHES SHALL BE EXAMINED CRITICALLY. ANY TRENCHES FOUND TO HAVE SOFT, UNSTABLE OR UNSUITABLE BACKFILL MATERIAL, IN THE OPINION OF THE THIRD PARTY TESTING COMPANY, THAT ARE TO BE WITHIN THE ZONE OF INFLUENCE OF PROPOSED BUILDINGS OR
- 10. ON-SITE FILL CAN BE USED IF THE SPECIFIED COMPACTION REQUIREMENTS CAN BE ACHIEVED. IF ON-SITE SOIL IS USED, IT SHOULD BE CLEAN AND FREE OF FROZEN SOIL, ORGANICS, OR OTHER DELETERIOUS MATERIALS.
- I. THE FINAL SUBGRADE/EXISTING AGGREGATE BASE SHOULD BE THOROUGHLY PROOFROLLED USING A FULLY LOADED TANDEM AXLE TRUCK OR FRONT END LOADER UNDER THE OBSERVATION OF A GEOTECHNICAL/PAVEMENT ENGINEER. LOOSE OR YIELDING AREAS THAT CANNOT BE MECHANICALLY STABILIZED SHOULD BE REINFORCED USING GEOGRIDS OR REMOVED AND REPLACED WITH ENGINEERED FILL OR AS DICTATED BY FIELD CONDITIONS.
- 12. SUBGRADE UNDERCUTTING, INCLUDING BACKFILLING SHALL BE PERFORMED TO REPLACE MATERIALS SUSCEPTIBLE TO FROST HEAVING AND UNSTABLE SOIL CONDITIONS. ANY EXCAVATIONS THAT MAY BE REQUIRED BELOW THE TOPSOIL IN FILL AREAS OR BELOW SUBGRADE IN CUT AREAS WILL BE CLASSIFIED AS SUBGRADE UNDERCUTTING.
- I3. SUBGRADE UNDERCUTTING SHALL BE PERFORMED WHERE NECESSARY AND THE EXCAVATED MATERIAL SHALL BECOME THE PROPERTY OF THE CONTRACTOR. ANY SUBGRADE UNDERCUTTING SHALL BE BACKFILLED AS RECOMMENDED IN THE GEOTECHNICAL ENGINEERING
- 14. ANY SUB-GRADE WATERING REQUIRED TO ACHIEVE REQUIRED DENSITY SHALL BE CONSIDERED INCIDENTAL TO THE JOB.

GENERAL UTILITY NOTES:


- ALL WORKMANSHIP AND MATERIALS SHALL BE IN ACCORDANCE WITH THE STANDARDS AND SPECIFICATIONS OF THE CITY.
- ALL TRENCHES UNDER OR WITHIN THREE (3) FEET OR THE FORTY-FIVE (45) DEGREE ZONE OF INFLUENCE LINE OF EXISTING AND/OR PROPOSED PAVEMENT, BUILDING PAD OR DRIVE APPROACH SHALL BE BACKFILLED WITH SAND COMPACTED TO AT LEAS' NINETY-FIVE (95) PERCENT OF MAXIMUM UNIT WEIGHT (ASTM D-1557). ALL OTHER TRENCHES TO BE COMPACTED TO 90% OR
- WHERE EXISTING MANHOLES OR SEWER PIPE ARE TO BE TAPPED, DRILL HOLES 4" CENTER TO CENTER, AROUND PERIPHERY OF OPENING TO CREATE A PLANE OF WEAKNESS JOINT BEFORE BREAKING SECTION OUT.
- THE LOCATIONS AND DIMENSIONS SHOWN ON THE PLANS FOR EXISTING UTILITIES ARE IN ACCORDANCE WITH AVAILABLE INFORMATION WITHOUT UNCOVERING AND MEASURING. THE DESIGN ENGINEER DOES NOT GUARANTEE THE ACCURACY OF THIS INFORMATION OR THAT ALL EXISTING UNDERGROUND FACILITIES ARE SHOWN. CONTRACTOR SHALL FIELD VERIFY UTILITIES.
- THE CONTRACTOR SHALL COORDINATE TO ENSURE ALL REQUIRED PIPES, CONDUITS, CABLES AND SLEEVES ARE PROPERLY PLACED FOR THE INSTALLATION OF GAS, ELECTRIC, PHONE, CABLE, IRRIGATION, ETC. IN SUCH A MANNER THAT WILL FACILITATE THEIR PROPER INSTALLATION PRIOR TO THE PLACEMENT OF THE PROPOSED PAVEMENT AND LANDSCAPING.
- 3. PIPE LENGTHS INDICATED ARE FROM CENTER OF STRUCTURE AND TO END OF FLARED END SECTION UNLESS NOTED OTHERWISE CONTRACTOR SHALL INSPECT ALL EXISTING PUBLIC STORM SEWER, SANITARY SEWER AND WATER MAIN STRUCTURES WITHIN THE LIMITS OF CONSTRUCTION AND WITH THE GOVERNING AGENCY INSPECTOR PRIOR TO ESTABLISHING FINAL GRADE. NOTIFY THE ENGINEER, OWNER/DEVELOPER, AND GOVERNING AGENCY IF STRUCTURE IS DEEMED TO BE STRUCTURALLY UNSOUND AND/OR IN NEED OF REPAIR.


STORM SEWER NOTES:


- ALL STORM SEWER 12" DIAMETER OR LARGER SHALL BE REINFORCED CONCRETE PIPE (RCP C-76) CLASS IV WITH MODIFIED TONGUE AND GROOVE JOINT WITH RUBBER GASKETS UNLESS SPECIFIED OTHERWISE (ASTM C-443).
- 2. ALL STORM SEWER LEADS SHALL BE CONSTRUCTED AT 1.00% MINIMUM SLOPE.
- ALL STORM SEWER 10" OR LESS AND/OR LEADS SHALL BE SDR 26.
- . JOINTS FOR P.V.C. PIPE SHALL BE ELASTOMERIC (RUBBER GASKET) AS SPECIFIED IN A.S.T.M. DESIGNATION D-3212.


CONSTRUCTION MATERIAL SUBMITTALS


- UNLESS REQUIRED OTHERWISE IN THE PROJECT SPECIFICATIONS, THE CONTRACTOR SHALL ONLY SUBMIT THE FOLLOWING CONSTRUCTION MATERIAL SUBMITTALS, AS APPLICABLE TO THE PLANS, FOR REVIEW BY THE ENGINEER. UNLESS APPROVED IN ADVANCE AND IN WRITING BY THE ENGINEER, ANY MATERIAL SUBMITTALS PROVIDED TO THE ENGINEER FOR REVIEW IN ADDITION TO THIS LIST SHALL BE RETURNED TO THE CONTRACTOR WITHOUT A REVIEW BEING PERFORMED.
- SOIL EROSION AND SEDIMENTATION CONTROL MEASURES
- UTILITY TRENCH BACKFILL MATERIAL WITH ALL MATERIAL DATA INCLUDED IN THE SUBMITTAL BEING DATED WITHIN 60 DAYS OF THE SUBMITTAL UNLESS APPROVED OTHERWISE BY THE ENGINEER
- 3. RIP RAP MATERIAL WITH ALL MATERIAL DATA INCLUDED IN THE SUBMITTAL BEING DATED WITHIN 60 DAYS OF THE SUBMITTAL UNLESS APPROVED OTHERWISE BY THE ENGINEER
- 4. STORM SEWER PIPING INCLUDING JOINTS
- 6. STORM SEWER STRUCTURE FRAME AND COVERS INCLUDING CLEAN OUTS
- . PAVEMENT AGGREGATE BASE MATERIAL WITH ALL MATERIAL DATA INCLUDED IN THE SUBMITTAL BEING DATED WITHIN 60 DAYS OF THE SUBMITTAL UNLESS APPROVED OTHERWISE BY THE ENGINEER
- 8. PAVEMENT UNDERDRAIN MATERIAL AND BACKFILL WITH ALL BACKFILL MATERIAL DATA INCLUDED IN THE SUBMITTAL BEING DATED WITHIN 60 DAYS OF THE SUBMITTAL UNLESS APPROVED OTHERWISE BY THE ENGINEER
- PAVEMENT MIX DESIGNS SUBMITTED FOR REVIEW BY THE ENGINEER MUST FOLLOW THE CURRENT MDOT REVIEW CHECKLISTS AS SUMMARIZED BELOW AND ALL MATERIAL DATA INCLUDED IN THE SUBMITTAL BEING DATED WITHIN 60 DAYS OF THE SUBMITTAL
- UNLESS APPROVED OTHERWISE BY THE ENGINEER: •8.1. CONCRETE MIX DESIGN REVIEW CHECKLIST (FORM 2000)
- •8.2. SUPERPAVE MIX DESIGN CHECKLIST (FORM 1862) •8.3. MARSHALL MIX DESIGN CHECKLIST (FORM 1849)
- 10. SITE FENCING AND GATES INCLUDING FOOTINGS
- 11. SITE RAILINGS INCLUDING FOOTING OR EMBEDMENTS
- 12. ANY ITEMS SHOWN IN THE PLANS OR DETAIL SHEETS THAT SPECIFICALLY STATE FOR THE CONTRACTOR TO SUBMIT A SHOP DRAWING TO THE ENGINEER FOR REVIEW. THESE ITEMS INCLUDE, BUT ARE NOT LIMITED TO:
- •• RETAINING WALL MATERIAL AND STRUCTURAL CALCULATIONS
- TRENCH DRAIN MATERIAL AND SHOP DRAWING DEPICTING THE LAYOUT OF THE SYSTEM
- ANY SPECIALITY ITEMS SHOWN IN THE PLANS OR DETAIL SHEETS THAT SPECIFICALLY DO NOT STATE FOR THE CONTRACTOR SHALL SUBMIT A SHOP DRAWING TO THE ENGINEER FOR REVIEW BUT THE CONTRACTOR REQUESTS TO BE REVIEWED. THE CONTRACTOR'S REQUEST FOR REVIEW MUST BE IN WRITING AND APPROVED BY THE ENGINEER PRIOR TO SUBMITTING THE

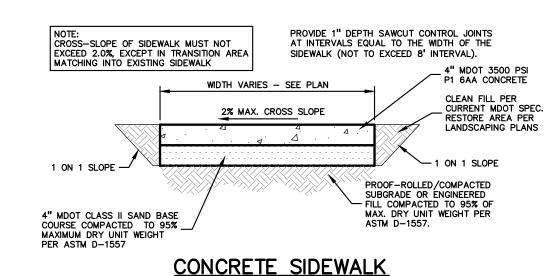

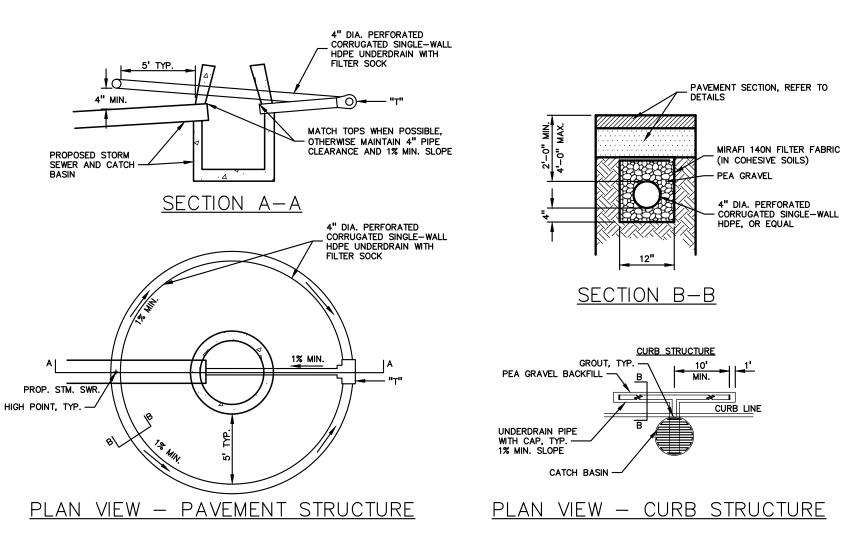


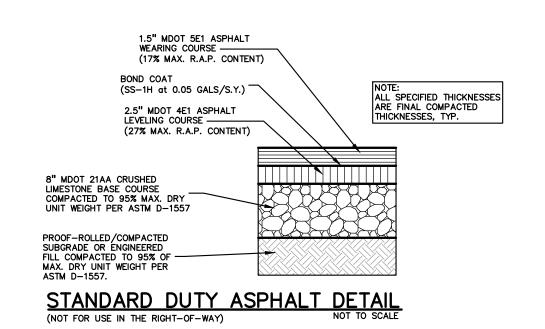

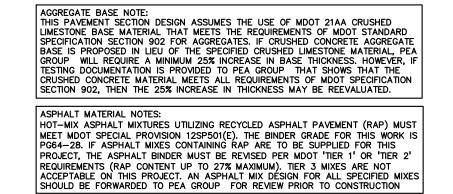

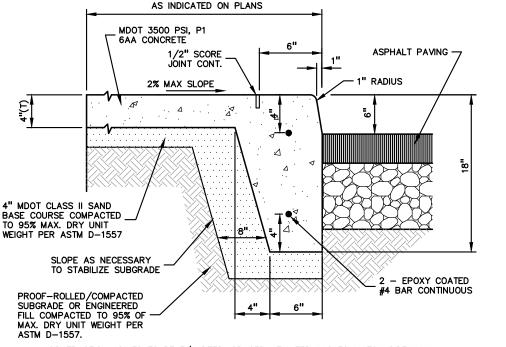


CONTRACTION JOINTS TO BE T/4 DEEP. SPACED AT INTERVALS TO MATCH SIDEWALK WIDTH (SAWCUT), 1/2-INCH PRE-MOLDED FILLER EXPANSION JOINTS WITH JOINT INTEGRAL CURB AND SIDEWAL

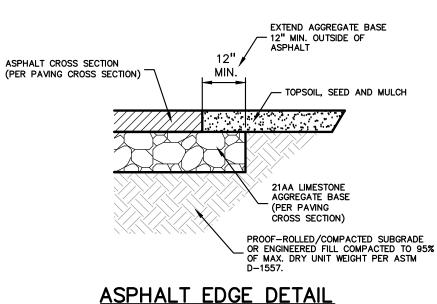

PROOF-ROLLED/COMPACTED SUBGRADE OR ENGINEERED FILL COMPACTED TO 95% OF MAX. DRY UNIT WEIGHT PER ASTM D-1557.

ADJACENT ASPHAL

PAVEMENT SECTION

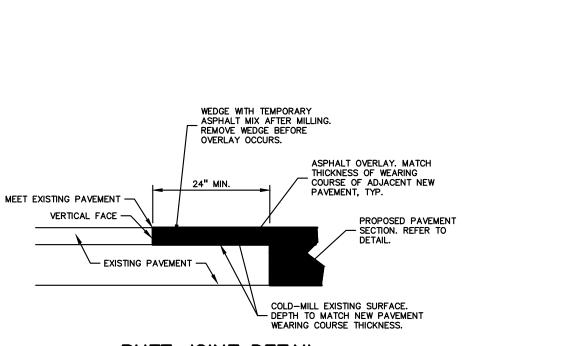

PROVIDE 1-1/2" CONTROL JOINTS AT INTERVALS EQUAL TO THE WIDTH OF THE SIDEWALK.

WIDTH TO MATCH DRIVE APPROACH

PLANE OF WEAKNESS JOINT

BUTT JOINT DETAIL


4" MDOT #21AA CRUSHED LIMESTONE BASE COURSE


COMPACTED TO 95% MAX. DRY UNI

SIDEWALK. SEE DETAIL.


1/2" EXPANSION JOINT SEALED WITH POLYURETHANE SEALANT

1 ON 1 SLOPE

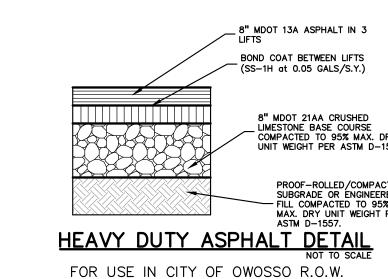


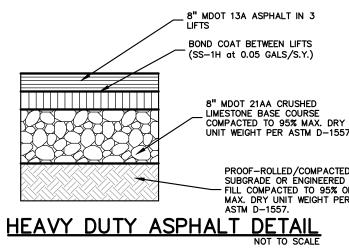



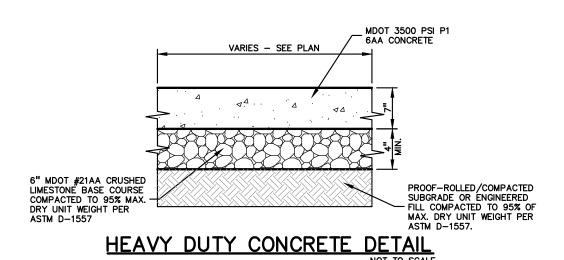

DRIVEWAY APPROACHES IN R.O.W.

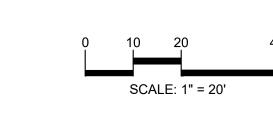

CAUTION!!


THE LOCATIONS AND ELE

TILITIES AS SHOWN ON THIS DRAWING ARE ONLY

PRIOR TO THE START OF CONSTRUCTION.

MPLIED AS TO THE COMPLETENESS OR ACCURACY THEREOF. THE CONTRACTOR SHALL BE EXCLUSIVELY RESPONSIBLE FOR

DETERMINING THE EXACT UTILITY LOCATIONS AND ELEVATIONS

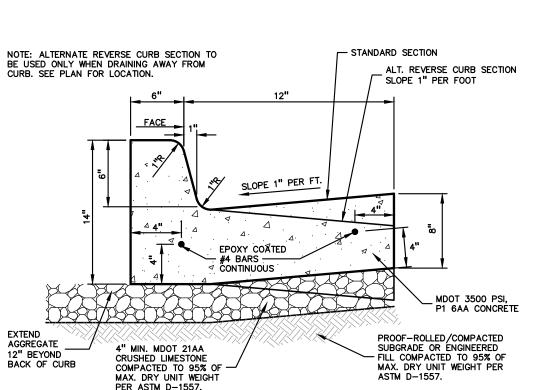

PROVIDE CONTROL JOINTS IN CURB AT 10' O.C. PROVIDE EXPANSION JOINT AND JOINT SEALANT AT END OF RADIUS RETURNS PER MDOT AND ACA STANDARDS. PROVIDE EXPANSION JOINTS AND JOINT SEALANT WHERE CURBS ABUT STRUCTURES. 18"x6" STANDARD CONCRETE CURB AND GUTTER

TOP OF CONCRETE - COLLAR TO MATCH


PAVEMENT ELEVATION


SLOPE TO PROVIDE POSITIVE DRAINAGE TOWARD CATCH BASIN

FOR MANHOLE STRUCTURE)

(CONSTRUCT FLUSH WITH PAVEMENT



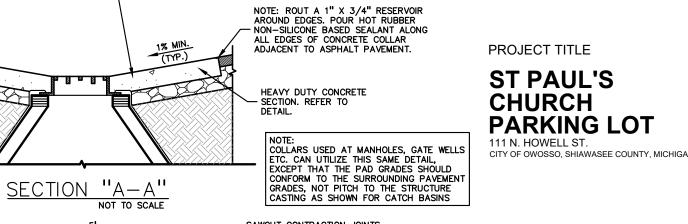

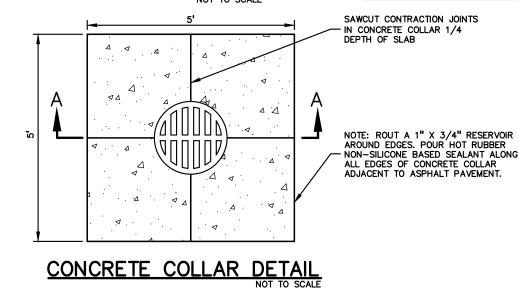

_ 7" NON-REINFORCED MDOT 3500 PSI P1 6AA CONCRETE

___ 1 ON 1 SLOPE

SIDEWALK. SEE DETAIL.

ORIGINAL ISSUE DATE: JUNE 23, 2022

DRAWING TITLE

NOTES &

REVISIONS

REV PER CITY

DETAILS PEA JOB NO.

2022-0249 WR WR DES. DRAWING NUMBER:

THICKENED SIDEWALK AT DRIVE APPROACH DETAIL NOT FOR CONSTRUCTION


PROOF-ROLLED / COMPACTED SUBGRADE OR ENGINEERED FILL COMPACTED TO 95% OF

MAX. DRY UNIT WEIGHT PER ASTM D-1557.

BARRIER FREE SIGN NOTES:


- ONE SIGN IS REQUIRED AT EACH BARRIER FREE PARKING SPACE.
 ALL SIGNS SHALL COMPLY WITH THE LATEST STANDARDS OF THE MICHIGAN MANUAL OF UNIFORM TRAFFIC CONTROL DEVICES (MMUTCD).
- 3. WHEN TWO BARRIER FREE PARKING SPACES ARE ADJACENT AND FACING EACH
- OTHER, TWO SIGNS ARE REQUIRED, BUT CAN BE MOUNTED ON THE SAME POST. 4. SIGN POSTS SHALL BE 2" NOM. SQUARE 14-GAUGE GALVANIZED STEEL TUBE WITH 7/16" HOLES AT 1" CENTERS. POSTS SHALL TELESCOPE INSIDE ANCHOR POSTS A
- MINIMUM OF 12". 5. ANCHOR POSTS SHALL BE 2.25" NOM. SQUARE 12-GAUGE GALVANIZED STEEL POST,
- A MINIMUM OF 3 FEET LONG. 6. IF THESE NOTES AND DETAILS CONFLICT WITH LOCAL CODES AND ORDINANCES, THE
- STRICTER REQUIREMENT SHOULD BE USED.


 7. ALTERNATE MATERIALS MAY BE USED IF IN COMPLIANCE WITH A.D.A. GUIDELINES AND LOCAL REQUIREMENTS.

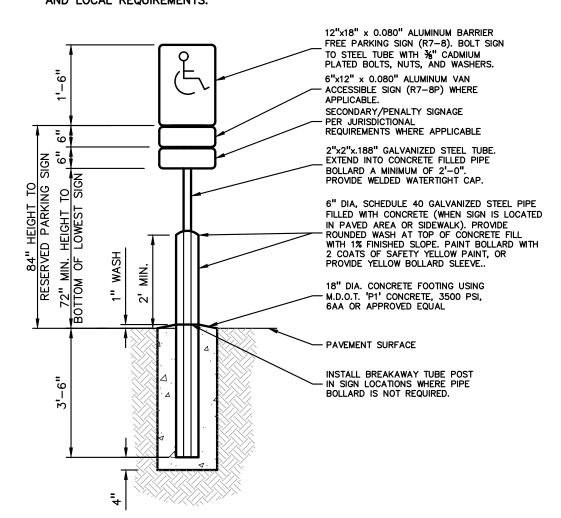


BARRIER FREE SIGN AND POST DETAIL




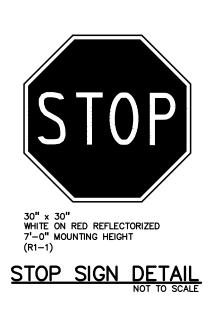

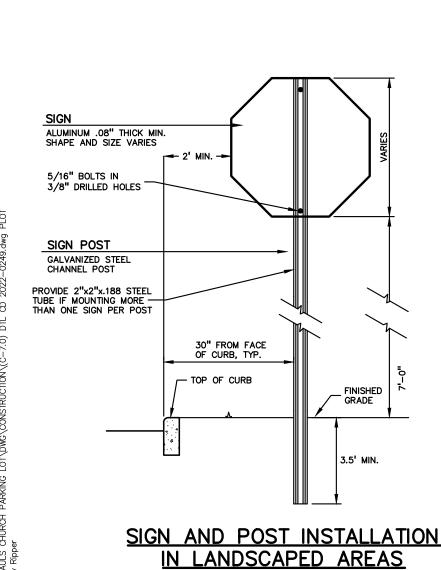

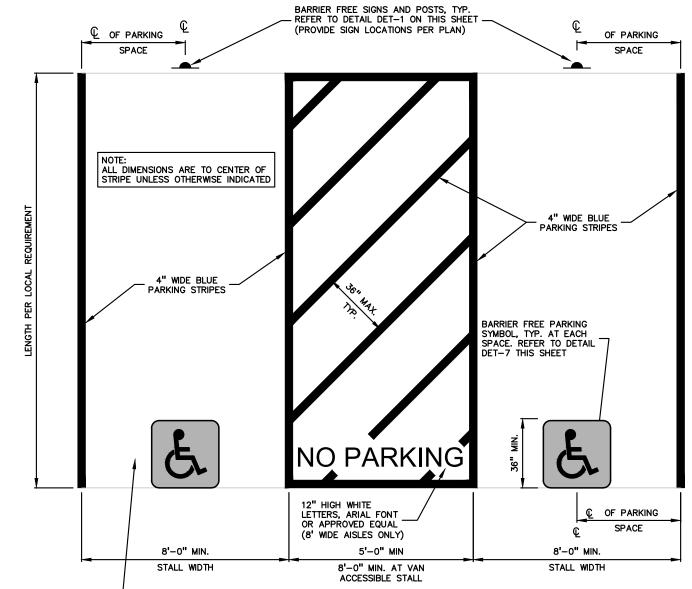

VAN ACCESSIBLE SPACES MUST BE LOCATED TO THE LEFT OF ALTERNATE BARRIER FREE PARKING STALL DETAIL

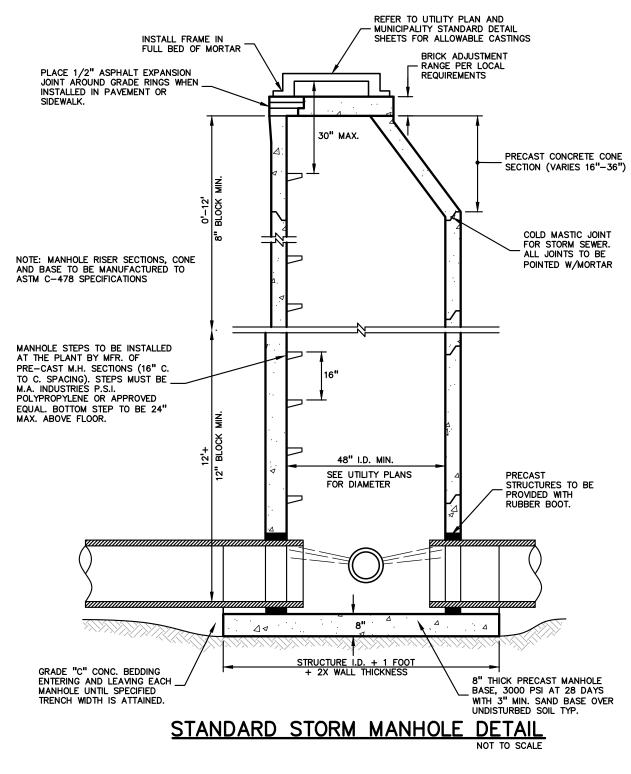

/- §" X 6" PICKETS

FENCE DETAILS:

COLOR: NATURAL


ELEVATION

WOOD PRIVACY FENCE DETAIL

12" MIN_

_ 2'X3'X8' BACK RAILS



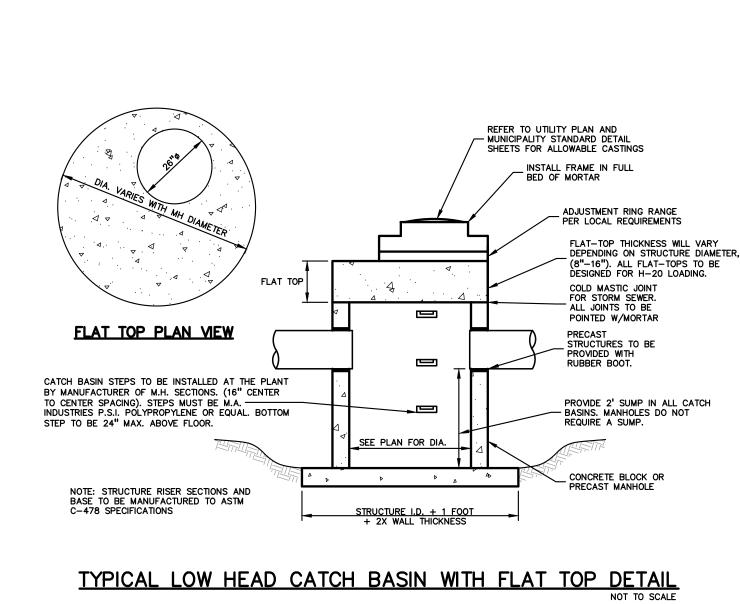

DUMPSTER ENCLOSURE WALL CROSS SECTION

NOT TO SCALE

MDOT 3500 PSI P1 6AA CONCRETE

PROOF-ROLLED/COMPACTED

SUBGRADE OR ENGINEERED
FILL COMPACTED TO 95% OF MAX. DRY UNIT WEIGHT PER ASTM D-1557.

- ARCHITECTURAL MASONRY TO MATCH BUILDING

-#4 AT 16" O.C. VERT. FULLY GROUTED

-INVESTIGATION OR THE ARCHITECTURAL PLAN
PLACE ON NATURAL SOILS OF AT LEAST 1500
PSF OR ENGINEERED FILL

SEE PLAN FOR GATE LOCATION

-12" MIN. OVERLAP W/FOOTING BARS., TYP.

VARIES - SEE PLAN

HEAVY DUTY CONCRETE PAD DETAIL

6" MDOT #21AA CRUSHED LIMESTONE BASE COURSE COMPACTED TO 95% MAX. -DRY UNIT WEIGHT PER ASTM D-1557

8" MASONRY BLOCK -

PROVIDE 1/2"x8"
FIBER JOINT FILLER —
BETWEEN SLAB &

WALL ASTM (D1751)

HEAVY DUTY CONCRETE PAD -

ELEVATION

6" Ø STANDARD PIPE

1'-6" Ø CONC. BASE-

NO. 6-14" LONG REINF. BAR EACH -WAY THRU PIPE


WHEN NOT ADDRESSED IN

INVESTIGATION OR THE ARCHITECTURAL PLAN PLACE ON NATURAL SOILS OF AT LEAST 1500 PSF NET ALLOWABLE BEARING


CAPACITY OR DOCUMENTED ENGINEERED


PAVEMENT -

W/CONC. FILL PAINT WITH REFLECTIVE YELLOW PAINT

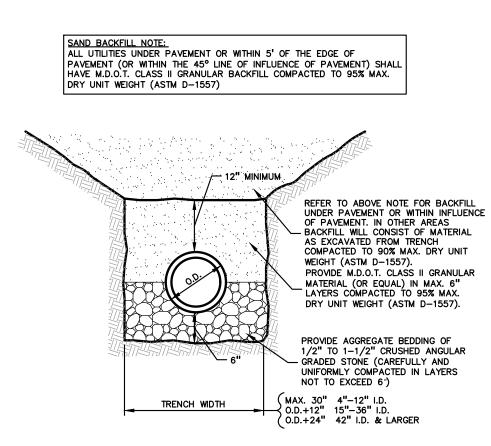


STANDARD PIPE BEDDING FOR RIGID PIPE

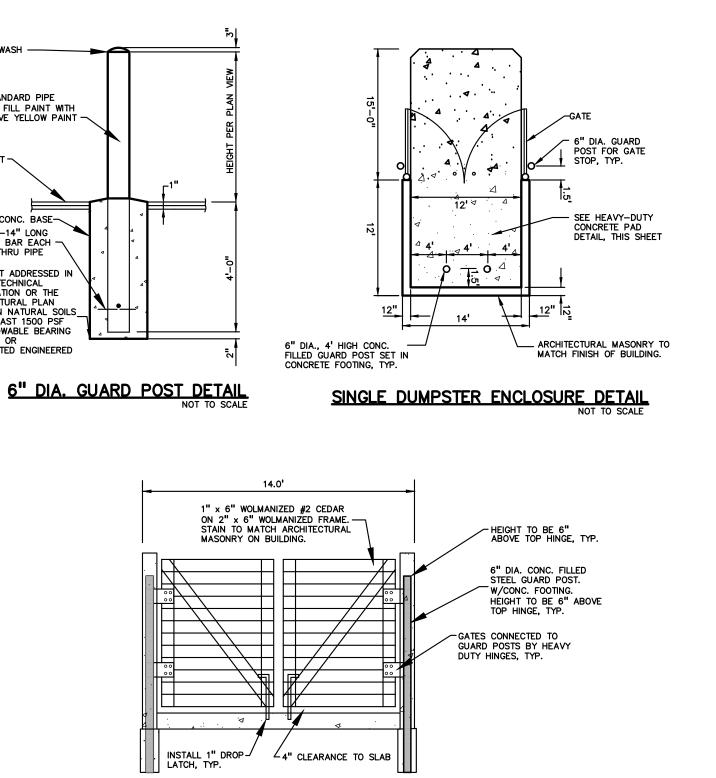

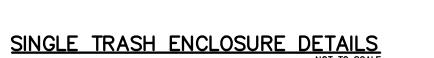

TRASH ENCLOSURE GATE DETAIL

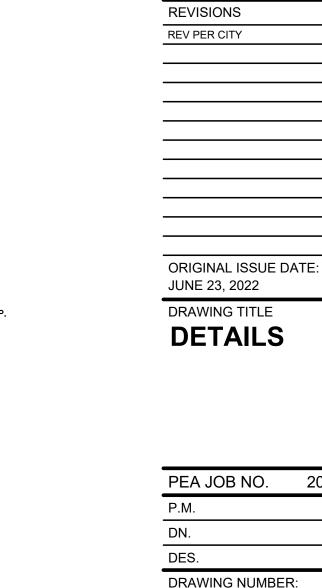

-4 x 4 PRESSURE TREATED PINE POST BEHIND FENCE PANEL - 6'X8' PRESSURE TREATED DOG EAR FENCE PANEL 4 x 4 PRESSURE TREATED PINE POST 1 x 6 PRESSURE TREATED PINE DOG-EAR PICKETS MOUNTED WITH ___ NO GAPS REFER TO UTILITY PLAN AND — MUNICIPALITY STANDARD DETAIL SHEETS FOR ALLOWABLE CASTINGS COLD MASTIC JOINT FOR STORM SEWER. ALL JOINTS TO BE BRICK ADJUSTMENT RANGE PER LOCAL REQUIREMENTS POINTED W/MORTAR FORM CONCRETE FILLET
SLOPED TO OUTLET PIPE, TYP PRECAST STRUCTURES

TO BE PROVIDED WITH RUBBER BOOT. OUTLET PIPE 4' HIGH, 8' PANEL, PRESSURE TREATED PINE DOG-EAR PICKETS APPROVED EQUAL. CONCRETE FOOTING 4 x 4 SQUARE PRESSURE TREATED PINE CONCRETE FOOTING INSTALL 8" THICK PRECAST OR POURED (3000 PSI) CONCRETE BASE (3000 PSI AT 28 DAYS). _ PROVIDE 2" MIN. SAND SUBBASE IF INSTALLING A PRECAST BASE. WHEN NOT ADDRESSED IN THE GEOTECHNICAL INVESTIGATION OR THE ARCHITECTURAL PLAN PLACE ON NATURAL SOILS OF AT LEAST ——
1500 PSF NET ALLOWABLE BEARING CAPACITY OR DOCUMENTED ENGINEERED FILL 2' DIA. INLET DETAIL

NOT FOR CONSTRUCTION

C-7.1

2022-0249

WR

WR

GROUP

t: 844.813.2949

www.peagroup.com

SCALE: 1" = 20'

THE LOCATIONS AND ELEVATIONS OF EXISTING UNDERGROUND UTILITIES AS SHOWN ON THIS DRAWING ARE ONLY

UTILLITIES AS SHOWN ON THIS DRAWING ARE ONLY APPROXIMATE. NO GUARANTEE IS EITHER EXPRESSED OR IMPLIED AS TO THE COMPLETENESS OR ACCURACY THEREOF. THE CONTRACTOR SHALL BE EXCLUSIVELY RESPONSIBLE FOR DETERMINING THE EXACT UTILITY LOCATIONS AND ELEVATIONS PRIOR TO THE START OF CONSTRUCTION.

ST PAUL CATHOLIC

CAUTION!!

CLIENT

CHURCH 111 N. HOWELL ST.

PROJECT TITLE

CHURCH

111 N. HOWELL ST.


ST PAUL'S

PARKING LOT

CITY OF OWOSSO, SHIAWASEE COUNTY, MICHIGAN

7/12/22


OWOSSO, MI 48867

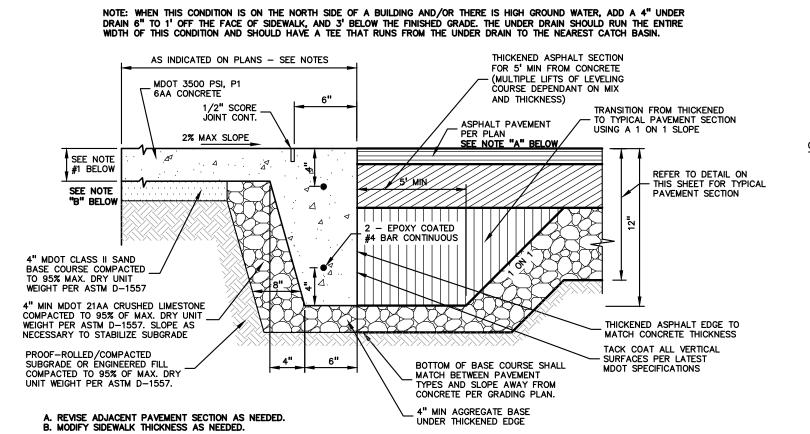


I. REFER TO THE PLANS AND CONCRETE SIDEWALK DETAIL FOR THICKNESS OF WALK.


2. REFER TO PAVING NOTES FOR SIDEWALK JOINTING. 3. WHERE CALLED FOR ON THE PLANS, THIS DETAIL CAN BE USED WHERE STOOPS/FROST SLABS ABUT FLUSH ASPHALT PAVEMENT. REFER TO THE ARCHITECT PLANS FOR THE STOOP/FROST SLAB DETAIL AND ANY ADDITIONAL INFORMATION FOR THE JOINTING WITH THE ASPHALT PAVEMENT.


THICKENED EDGE SIDEWALK TO FLUSH ASPHALT DETAIL

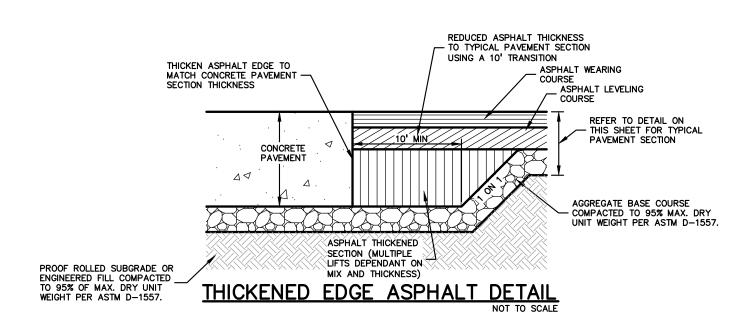


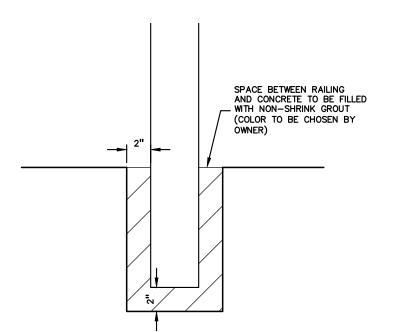


HANDRAIL EMBEDMENT DETAIL

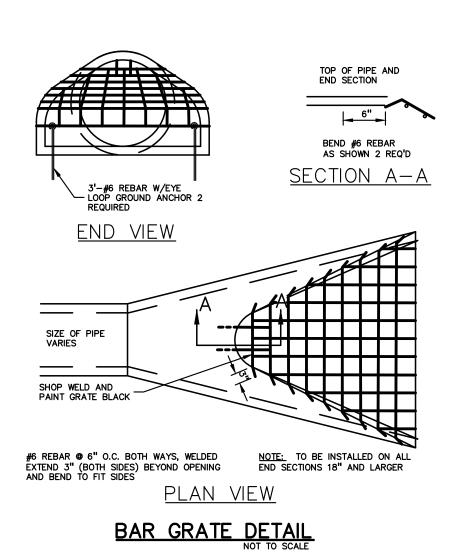

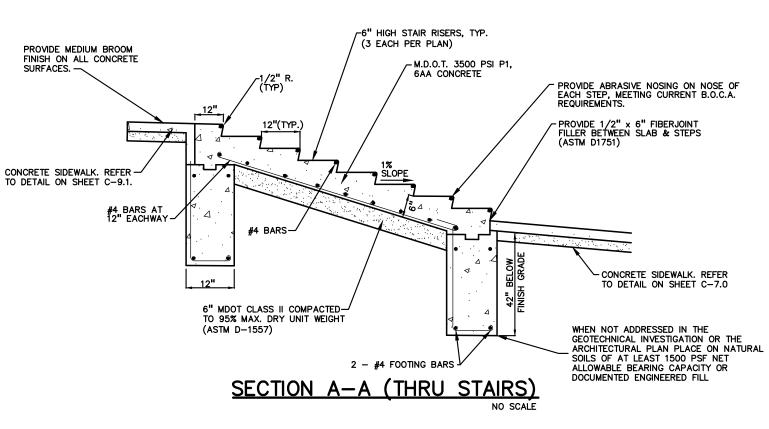


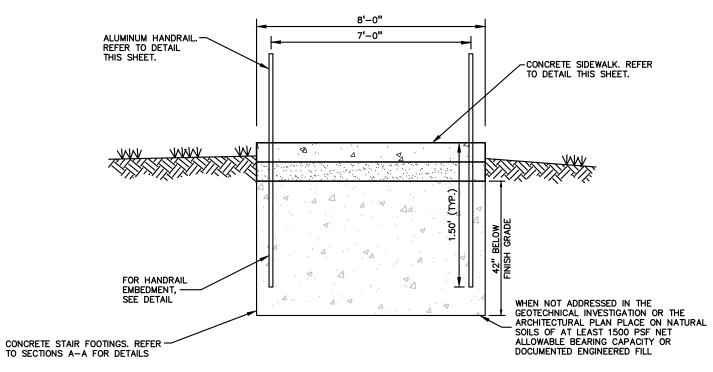

SECTION B-B (THRU STAIRS)

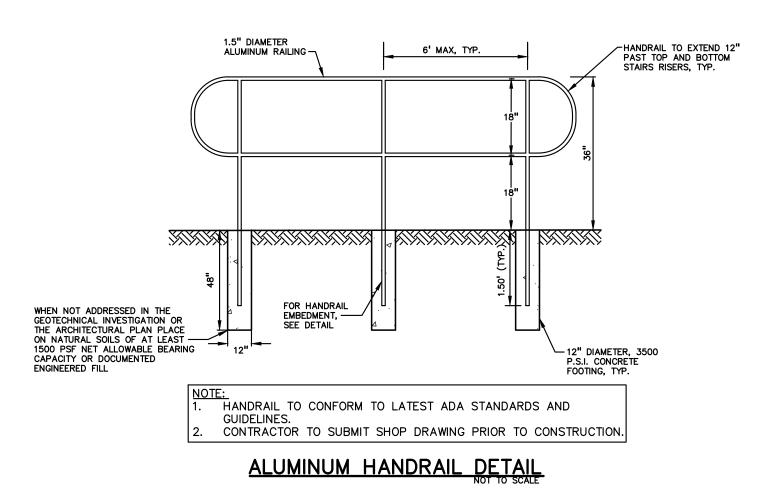


CONCRETE STAIRS AND WALK WITH HANDRAIL DETAIL

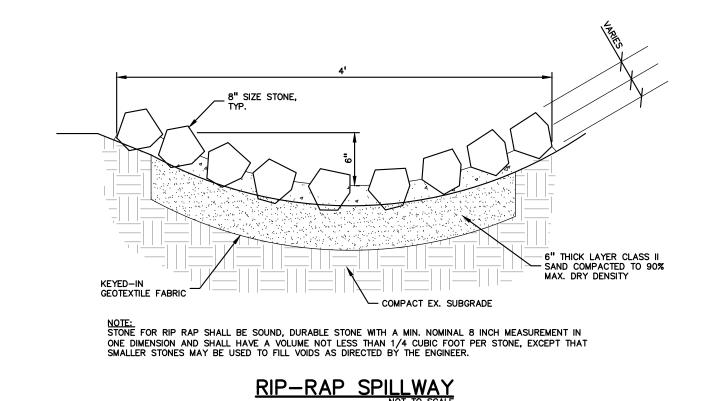


EROSION CONTROL STANDARDS:


- ALL EROSION AND SEDIMENT CONTROL WORK SHALL CONFORM TO STANDARDS AND SPECIFICATIONS OF THE JURISDICTIONAL AGENCY UNDER PART 91 OF ACT
- DAILY INSPECTIONS SHALL BE MADE BY CONTRACTOR WHILE WORKING TO DETERMINE THE EFFECTIVENESS OF EROSION AND SEDIMENT CONTROL MEASURES. ANY NECESSARY REPAIRS SHALL BE PERFORMED WITHOUT DELAY. ALL SOIL EROSION CONTROL PROVISIONS SHALL BE PROPERLY MAINTAINED DURING CONSTRUCTION.
- EROSION AND ANY SEDIMENTATION FROM WORK ON THIS SITE SHALL BE CONTAINED ON THE SITE AND NOT ALLOWED TO COLLECT ON ANY OFF- SITE AREAS OR IN WATERWAYS. WATERWAYS INCLUDE BOTH NATURAL AND MAN-MADE OPEN DITCHES, STREAMS, STORM DRAINS, LAKES, AND PONDS.
- CONTRACTOR SHALL APPLY TEMPORARY EROSION AND SEDIMENTATION CONTROL MEASURES WHEN REQUIRED AND AS DIRECTED ON THESE PLANS. CONTRACTOR SHALL REMOVE TEMPORARY MEASURES AS SOON AS PERMANENT PERMANENT STABILIZATION OF SLOPES, DITCHES, AND OTHER EARTH CHANGE AREAS HAVE BEEN COMPLETED.
- STAGING THE WORK WILL BE DONE BY THE CONTRACTOR AS DIRECTED IN THESE PLANS AND AS REQUIRED TO ENSURE PROGRESSIVE STABILIZATION OF
- SOIL EROSION CONTROL PRACTICES WILL BE ESTABLISHED IN EARLY STAGES OF CONSTRUCTION BY THE CONTRACTOR. SEDIMENT CONTROL PRACTICES WILL BE APPLIED AS A PERIMETER DEFENSE AGAINST ANY TRANSPORTING OF SILT OFF
- DUST SHALL BE CONTROLLED BY WATERING OR BY OTHER APPROVED MEANS THROUGHOUT ALL CONSTRUCTION OPERATIONS.
- PERMANENT SOIL EROSION CONTROL MEASURES FOR SLOPES, CHANNELS, DITCHES OR ANY DISTURBED LAND AREA SHALL BE COMPLETED WITHIN 5 CALENDAR DAYS AFTER FINAL GRADING OR THE FINAL EARTH CHANGE HAS BEEN COMPLETED. WHEN IT IS NOT POSSIBLE TO PERMANENTLY STABILIZE A DISTURBED AREA AFTER AN EARTH CHANGE HAS BEEN COMPLETED OR WHERE SIGNIFICANT EARTH CHANGE HAS BEEN COMPLETED OR WHERE SIGNIFICANT EARTH CHANGE ACTIVITY CEASES, TEMPORARY SOIL EROSION CONTROL MEASURES SHALL BE IMPLEMENTED WITHIN 5 CALENDAR DAYS. ALL TEMPORARY SOIL EROSION CONTROL MEASURES SHALL BE MAINTAINED UNTIL PERMANENT SOIL EROSION CONTROL MEASURES ARE IMPLEMENTED AND ESTABLISHED BEFORE A CERTIFICATE OF COMPLIANCE IS ISSUED.
-). THE CONTRACTOR SHALL PRESERVE NATURAL VEGETATION AS MUCH AS
- 10. ANY WORK OUTSIDE OF THE LIMITS OF DISTURBANCE SHALL REQUIRE A SEPARATE GRADING PERMIT.
- 1. FOLLOWING THE PLACEMENT OF 4" OF TOPSOIL AND HYDROSEED, STRAW MULCH BLANKET IS TO BE INSTALLED PERPENDICULAR ALONG THE PROPOSED SLOPES 1:4 OR STEEPER FROM TOP OF SLOPE TO TOE OF SLOPE, INCLUDING DITCH BOTTOMS, AND IT MUST BE PEGGED IN PLACE.
- 12. ALL MUD/DIRT TRACKED ONTO EXISTING COUNTY/CITY ROADS FROM THIS SITE, DUE TO CONSTRUCTION, SHALL BE PROMPTLY REMOVED BY THE CONTRACTOR.
- 13. TEMPORARY STABILIZATION OF THE ENTIRE SITE SHALL BE COMPLETED AND APPROVAL OBTAINED FROM THE LIVINGSTON COUNTY DRAIN COMMISSIONERS OFFICE PRIOR TO THE ISSUANCE OF ANY SINGLE FAMILY DWELLING PERMITS.

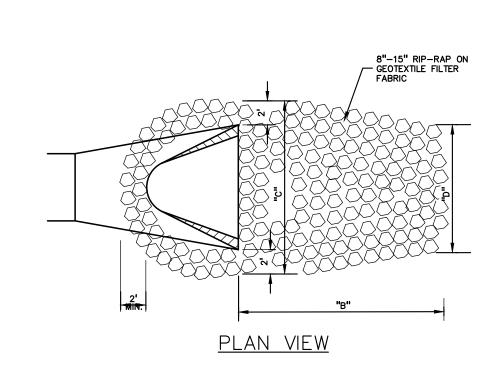


PIPE DIAMETER	"B"	"c"	"D"	SQUARE YARDS
12"	5'-0"	6'-6"	3'-0"	8.0
15"	5'-0"	7'-0"	3'-0"	8.5
18"	5'-0"	7'-6"	3'-6"	9.2
21"	5'-6"	8'-0"	4'-0"	10.7
24"	6'-0"	8'-6"	4'-6"	12.4

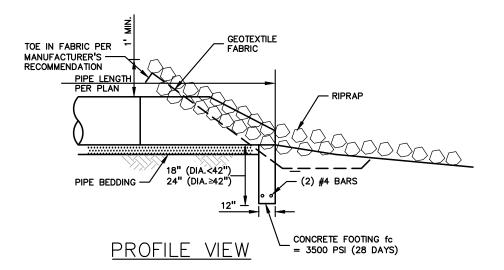

END SECTION & RIPRAP DETAIL

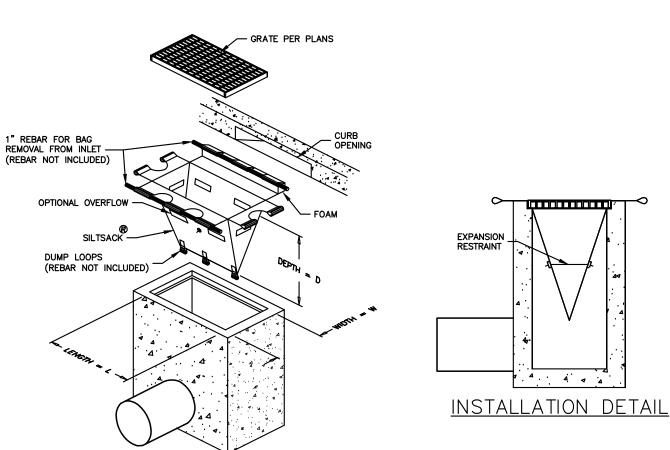

'SILTSACK' DETAIL

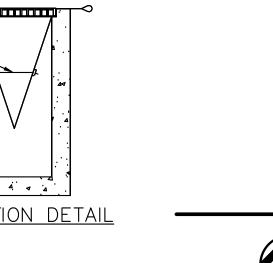




GROUP


t: 844.813.2949

www.peagroup.com

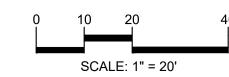





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GEOTEXTILE FILTER

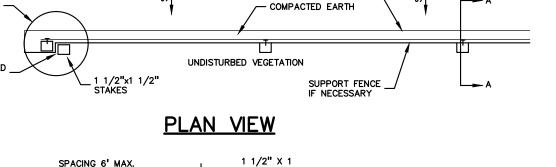

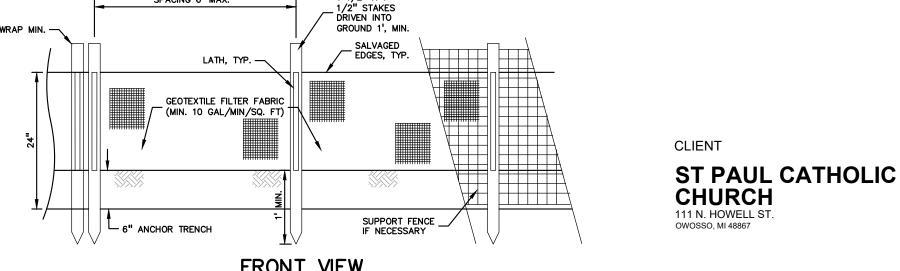

ST PAUL'S CHURCH **PARKING LOT** 111 N. HOWELL ST.

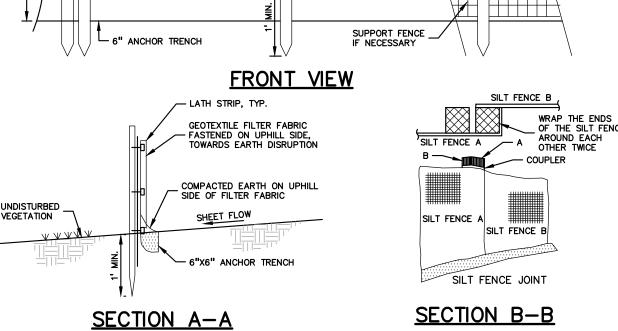PROJECT TITLE

CITY OF OWOSSO, SHIAWASEE COUNTY, MICHIGAN

REVISIONS **REV PER CITY**

SOIL EROSION SCHEDULE AND SEQUENCE OF CONSTRUCTION:

SILT FENCE DETAIL

- PLACE SILT FENCE AND SEDIMENT TRAPS AS INDICATED ON PLANS. NOTE THAT ALI SILT FENCE SHALL BE 36" HIGH, NO EXCEPTIONS
- INSTALL MUD MAT AT SITE ENTRANCE.
- REMOVE ALL TOPSOIL, ORGANIC MATTER, AND DELETERIOUS MATERIALS FROM AREAS TO BE GRADED. TOPSOIL MAY BE STORED ON SITE IN AREAS INDICATED AND USED FOR FUTURE PLANTING AND FILL AREAS IN GREENSPACE, BERMS, AND REAR YARDS. TRUCK TOPSOIL OFF SITE AT OWNER'S REQUEST. STOCKPILE AREAS SHALL BE SEEDED AND MULCHED OR MATTED WITH STRAW, AND PROVIDED WITH A PERIMETER OF SILT FENCE IMMEDIATELY FOLLOWING THE STRIPPING PROCESS.
- CONSTRUCT DETENTION PONDS AND SEDIMENTATION PONDS. PONDS SHALL BE TOPSOILED, SEEDED, MULCHED AND TACKED PRIOR TO ANY OTHER EARTH DISRUPTION.
- . GRADE PARKING TO PAVEMENT SUBGRADE ELEVATION. ROUGH GRADE SITE TO WITHIN 0.5' OF FINAL GRADE PRIOR TO BEGINNING UTILITY
- INSTALL UTILITIES. PLACE INLET FILTERS ON ALL CATCH BASINS AND INLETS.
- . PLACE LOT PAVING.
- REDISTRIBUTE TOPSOIL. SITE SHALL BE GRADED ACCORDING TO GRADING PLAN. FINAL GRADES WILL BE SET AT THE TIME SITE PLANS ARE AVAILABLE FOR EACH HOUSE.
- 10. INSTALL FRANCHISE UTILITIES (ELECTRIC, GAS, TELEPHONE).
- 11. ESTABLISH VEGETATION AND/OR LANDSCAPE ANY REMAINING DISTURBED AREAS. 12. CLEAN PAVEMENT AND STORM SEWERS.
- 13. REMOVE ALL SEDIMENT FROM SEDIMENT BASIN AND DETENTION POND.
- 14. REMOVE ALL TEMPORARY SEDIMENTATION AND EROSION CONTROLS.

ORIGINAL ISSUE DATE: JUNE 23, 2022

DRAWING TITLE

DETAILS

PEA JOB NO.	2022-0249
P.M.	TD
DN.	WR
DES.	WR
DRAWING NUMBE	R·

DETENTION

AREA

BRADLEY STREET (66' PUBLIC R.O.W.)

W. MAIN STREET (M-21)
(85' PUBLIC R.O.W.)

(9)

= PARKING LOT TREES = GREENBELT TREES = SHRUBS = PERENNIALS = SEED LAWN

KEY:



GROUP

t: 844.813.2949 www.peagroup.com

- LANDSCAPE CONTRACTOR SHALL VISIT SITE, INSPECT EXISTING SITE CONDITIONS AND REVIEW PROPOSED PLANTING AND RELATED WORK. IN CASE OF DISCREPANCY BETWEEN PLAN AND PLANT LIST, PLAN SHALL GOVERN QUANTITIES. CONTACT LANDSCAPE ARCHITECT WITH ANY CONCERNS.
- 3. ALL PLANT MATERIAL TO BE PREMIUM GRADE NURSERY STOCK AND SHALL SATISFY AMERICAN ASSOCIATION OF NURSERYMEN STANDARD FOR NURSERY STOCK. ALL LANDSCAPE MATERIAL SHALL BE NORTHERN GROWN, NO. 1. GRADE.
- CONTRACTOR IS RESPONSIBLE FOR VERIFYING ALL QUANTITIES SHOWN ON LANDSCAPE PLAN PRIOR TO PRICING THE WORK.
- 5. THE OWNER'S REPRESENTATIVE RESERVES THE RIGHT TO
- 6. ALL SINGLE STEM SHADE TREES TO HAVE STRAIGHT TRUNKS
- . ALL SINGLE TRUNK SHADE TREES TO HAVE A CENTRAL LEADER; TREES WITH FORKED OR IRREGULAR TRUNKS WILL

- 11. NO MACHINERY IS TO BE USED WITHIN THE DRIP LINE OF EXISTING TREES; HAND GRADE ALL LAWN AREAS WITHIN THE DRIP LINE OF EXISTING TREES.
- 12. ALL TREE LOCATIONS SHALL BE STAKED BY LANDSCAPE CONTRACTOR AND ARE SUBJECT TO THE APPROVAL OF THE LANDSCAPE ARCHITECT PRIOR TO INSTALLATION OF THE PLANT
- 13. IT IS MANDATORY THAT POSITIVE DRAINAGE IS PROVIDED AWAY FROM ALL BUILDINGS.



- 2. CONTRACTOR SHALL VERIFY LOCATIONS OF ALL ON SITE UTILITIES PRIOR TO BEGINNING CONSTRUCTION ON HIS/HER PHASE OF WORK. ELECTRIC, GAS, TELEPHONE, CABLE TELEVISION MAY BE LOCATED BY CALLING MISS DIG 1-800-482-7171. ANY DAMAGE OR INTERRUPTION OF SERVICES SHALL BE THE RESPONSIBILITY OF CONTRACTOR. CONTRACTOR SHALL COORDINATE ALL RELATED ACTIVITIES WITH OTHER TRADES ON THE JOB AND SHALL REPORT ANY UNACCEPTABLE JOB CONDITIONS TO OWNER'S REPRESENTATIVE PRIOR TO COMMENCING.

- REJECT ANY PLANT MATERIAL NOT MEETING SPECIFICATIONS.
- AND SYMMETRICAL CROWNS.
- 8. ALL MULTI STEM TREES SHALL BE HEAVILY BRANCHED AND HAVE SYMMETRICAL CROWNS. ONE SIDED TREES OR THOSE WITH THIN OR OPEN CROWNS SHALL NOT BE ACCEPTED.
- 9. ALL EVERGREEN TREES SHALL BE HEAVILY BRANCHED AND FULL TO THE GROUND, SYMMETRICAL IN SHAPE AND NOT
- SHEARED FOR THE LAST FIVE GROWING SEASONS. 10. ALL TREES TO HAVE CLAY OR CLAY LOAM BALLS, TREES WITH SAND BALLS WILL BE REJECTED.

- 14. ALL PLANTING BEDS SHALL RECEIVE 3" SHREDDED HARDWOOD BARK MULCH WITH PRE EMERGENT, SEE SPECIFICATIONS. SHREDDED PALETTE AND DYED MULCH WILL NOT BE ACCEPTED.
- 15. ALL LANDSCAPED AREAS SHALL RECEIVE 3" COMPACTED
- 16. SEE SPECIFICATIONS FOR ADDITIONAL COMMENTS, REQUIREMENTS, PLANTING PROCEDURES AND WARRANTY
- 17. CONTRACTOR SHALL NOT INSTALL PLANTS UNDER BUILDING OVERHANG AND SHALL NOTIFY LANDSCAPE ARCHITECT IF DRAWINGS CONFLICT WITH BUILDING OVERHANGS.
- 18. ALL LANDSCAPE AND LAWN AREAS TO BE IRRIGATED WITH AN AUTOMATED IRRIGATION SYSTEM.



CAUTION!! THE LOCATIONS AND ELEVATIONS OF EXISTING UNDERGROUND UTILITIES AS SHOWN ON THIS DRAWING ARE ONLY APPROXIMATE. NO GUARANTEE IS EITHER EXPRESSED OR IMPLIED AS TO THE COMPLETENESS OR ACCURACY THEREOF. THE CONTRACTOR SHALL BE EXCLUSIVELY RESPONSIBLE FOR DETERMINING THE EXACT UTILITY LOCATIONS AND ELEVATIONS PRIOR TO THE START OF CONSTRUCTION.

CLIENT

ST PAUL CATHOLIC CHURCH 111 N. HOWELL ST.

PROJECT TITLE

ST PAUL'S CHURCH **PARKING LOT** 111 N. HOWELL ST. CITY OF OWOSSO, SHIAWASEE COUNTY, MICHIGAN

REVISIONS REV PER CITY

ORIGINAL ISSUE DATE: JUNE 23, 2022


DRAWING TITLE **LANDSCAPE PLAN**


PEA JOB NO.	2022-0249
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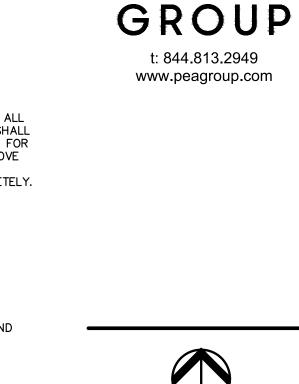
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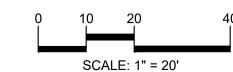




SHRUB PLANTING DETAIL SCALE: 1'' = 2' - 0''




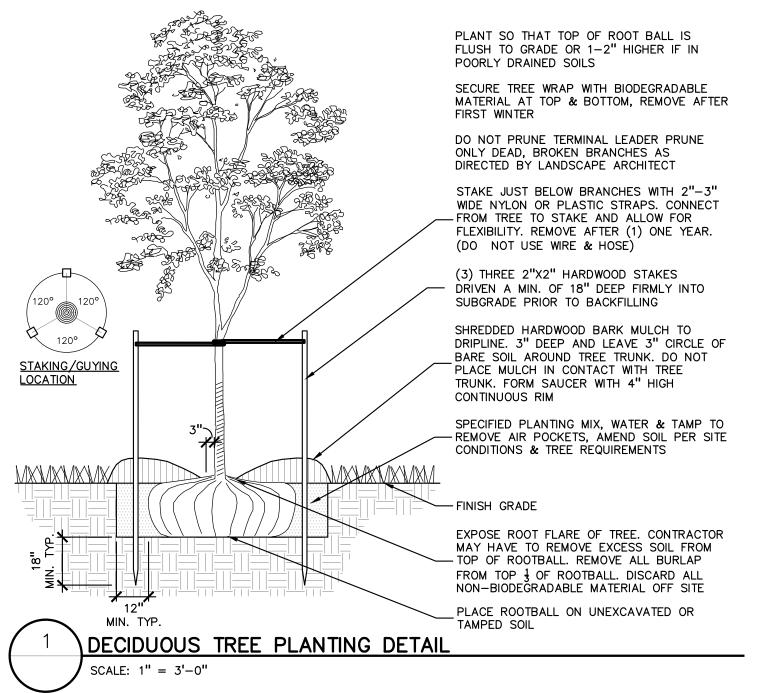

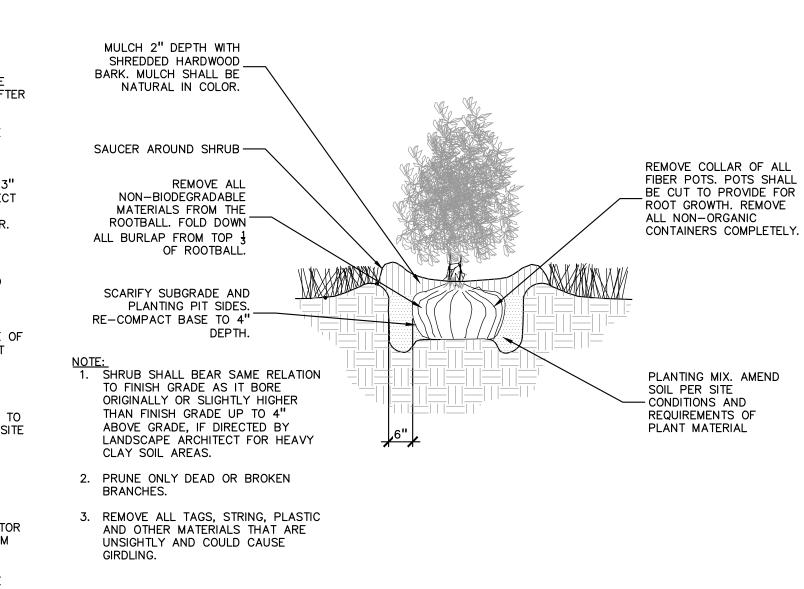




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PERENNIAL PLANTING DETAIL SCALE: 1'' = 2'-0''

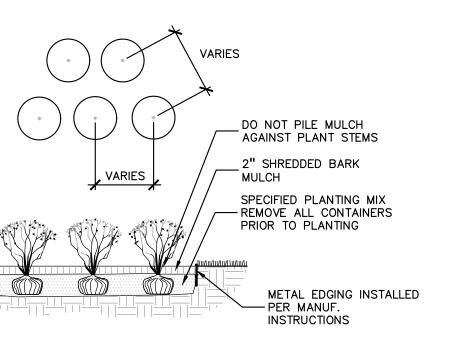

THICK X 5 ½" DEPTH WHEN ADJ. TO ROCK, FINISH: BLACK DURAFLEX MEETING AAMA 2603 STAKE SHALL SECURELY ENGAGE EDGING AND SHALL BE ENTIRELY BELOW TOP SURFACE OF EDGING

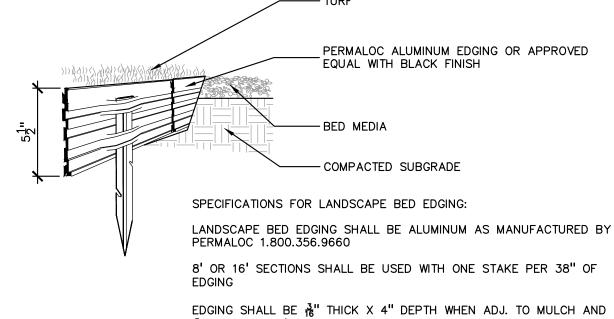EDGING SHALL HAVE A MINIMUM OF 2" OF INTERLOCKING OVERLAP BETWEEN SECTIONS

INSTALL AS PER MANUFACTURER'S SPECIFICATIONS WITH TOP OF EDGING $\frac{1}{4}$ " ABOVE COMPACTED FINISH GRADE. FINISH GRADE TO BE COMPACTED ON BOTH SIDES OF EDGING TO MAINTAIN STABILITY

ALUMINUM EDGE DETAIL SCALE: 1/2'' = 1'-0''

ST PAUL CATHOLIC CHURCH 111 N. HOWELL ST. 0W0SSO, MI 48867

CLIENT

PROJECT TITLE


ST PAUL'S CHURCH **PARKING LOT** 111 N. HOWELL ST. CITY OF OWOSSO, SHIAWASEE COUNTY, MICHIGAN

REVISIONS REV PER CITY ORIGINAL ISSUE DATE:

JUNE 23, 2022 DRAWING TITLE


LANDSCAPE **DETAILS**

PEA JOB NO.	2022-0249
P.M.	TD
DN.	WR
DES.	WR
DRAWING NUMBER	₹:

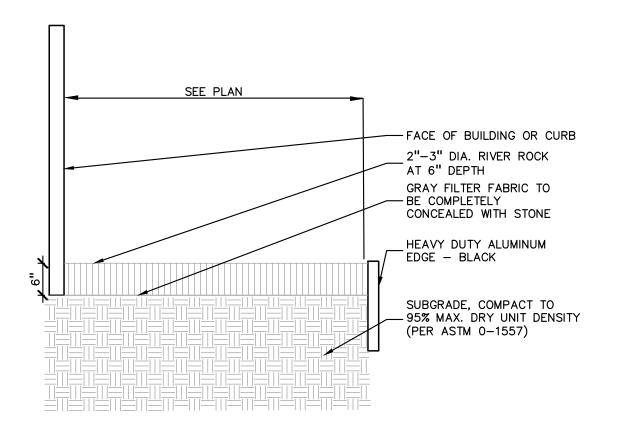

RIVER ROCK EDGE DETAIL SCALE: $1 \frac{1}{2}$ " = 1'-0"

Schedule									
Symbol	Label	Quantity	Manufacturer	Catalog Number	Description	Number Lamps	Lumens Per Lamp	Light Loss Factor	Wattage
	Α	4		DSX1 LED P8 50K T5W	DSX1 LED P8 50K T5W MVOLT	1	25331	0.95	414

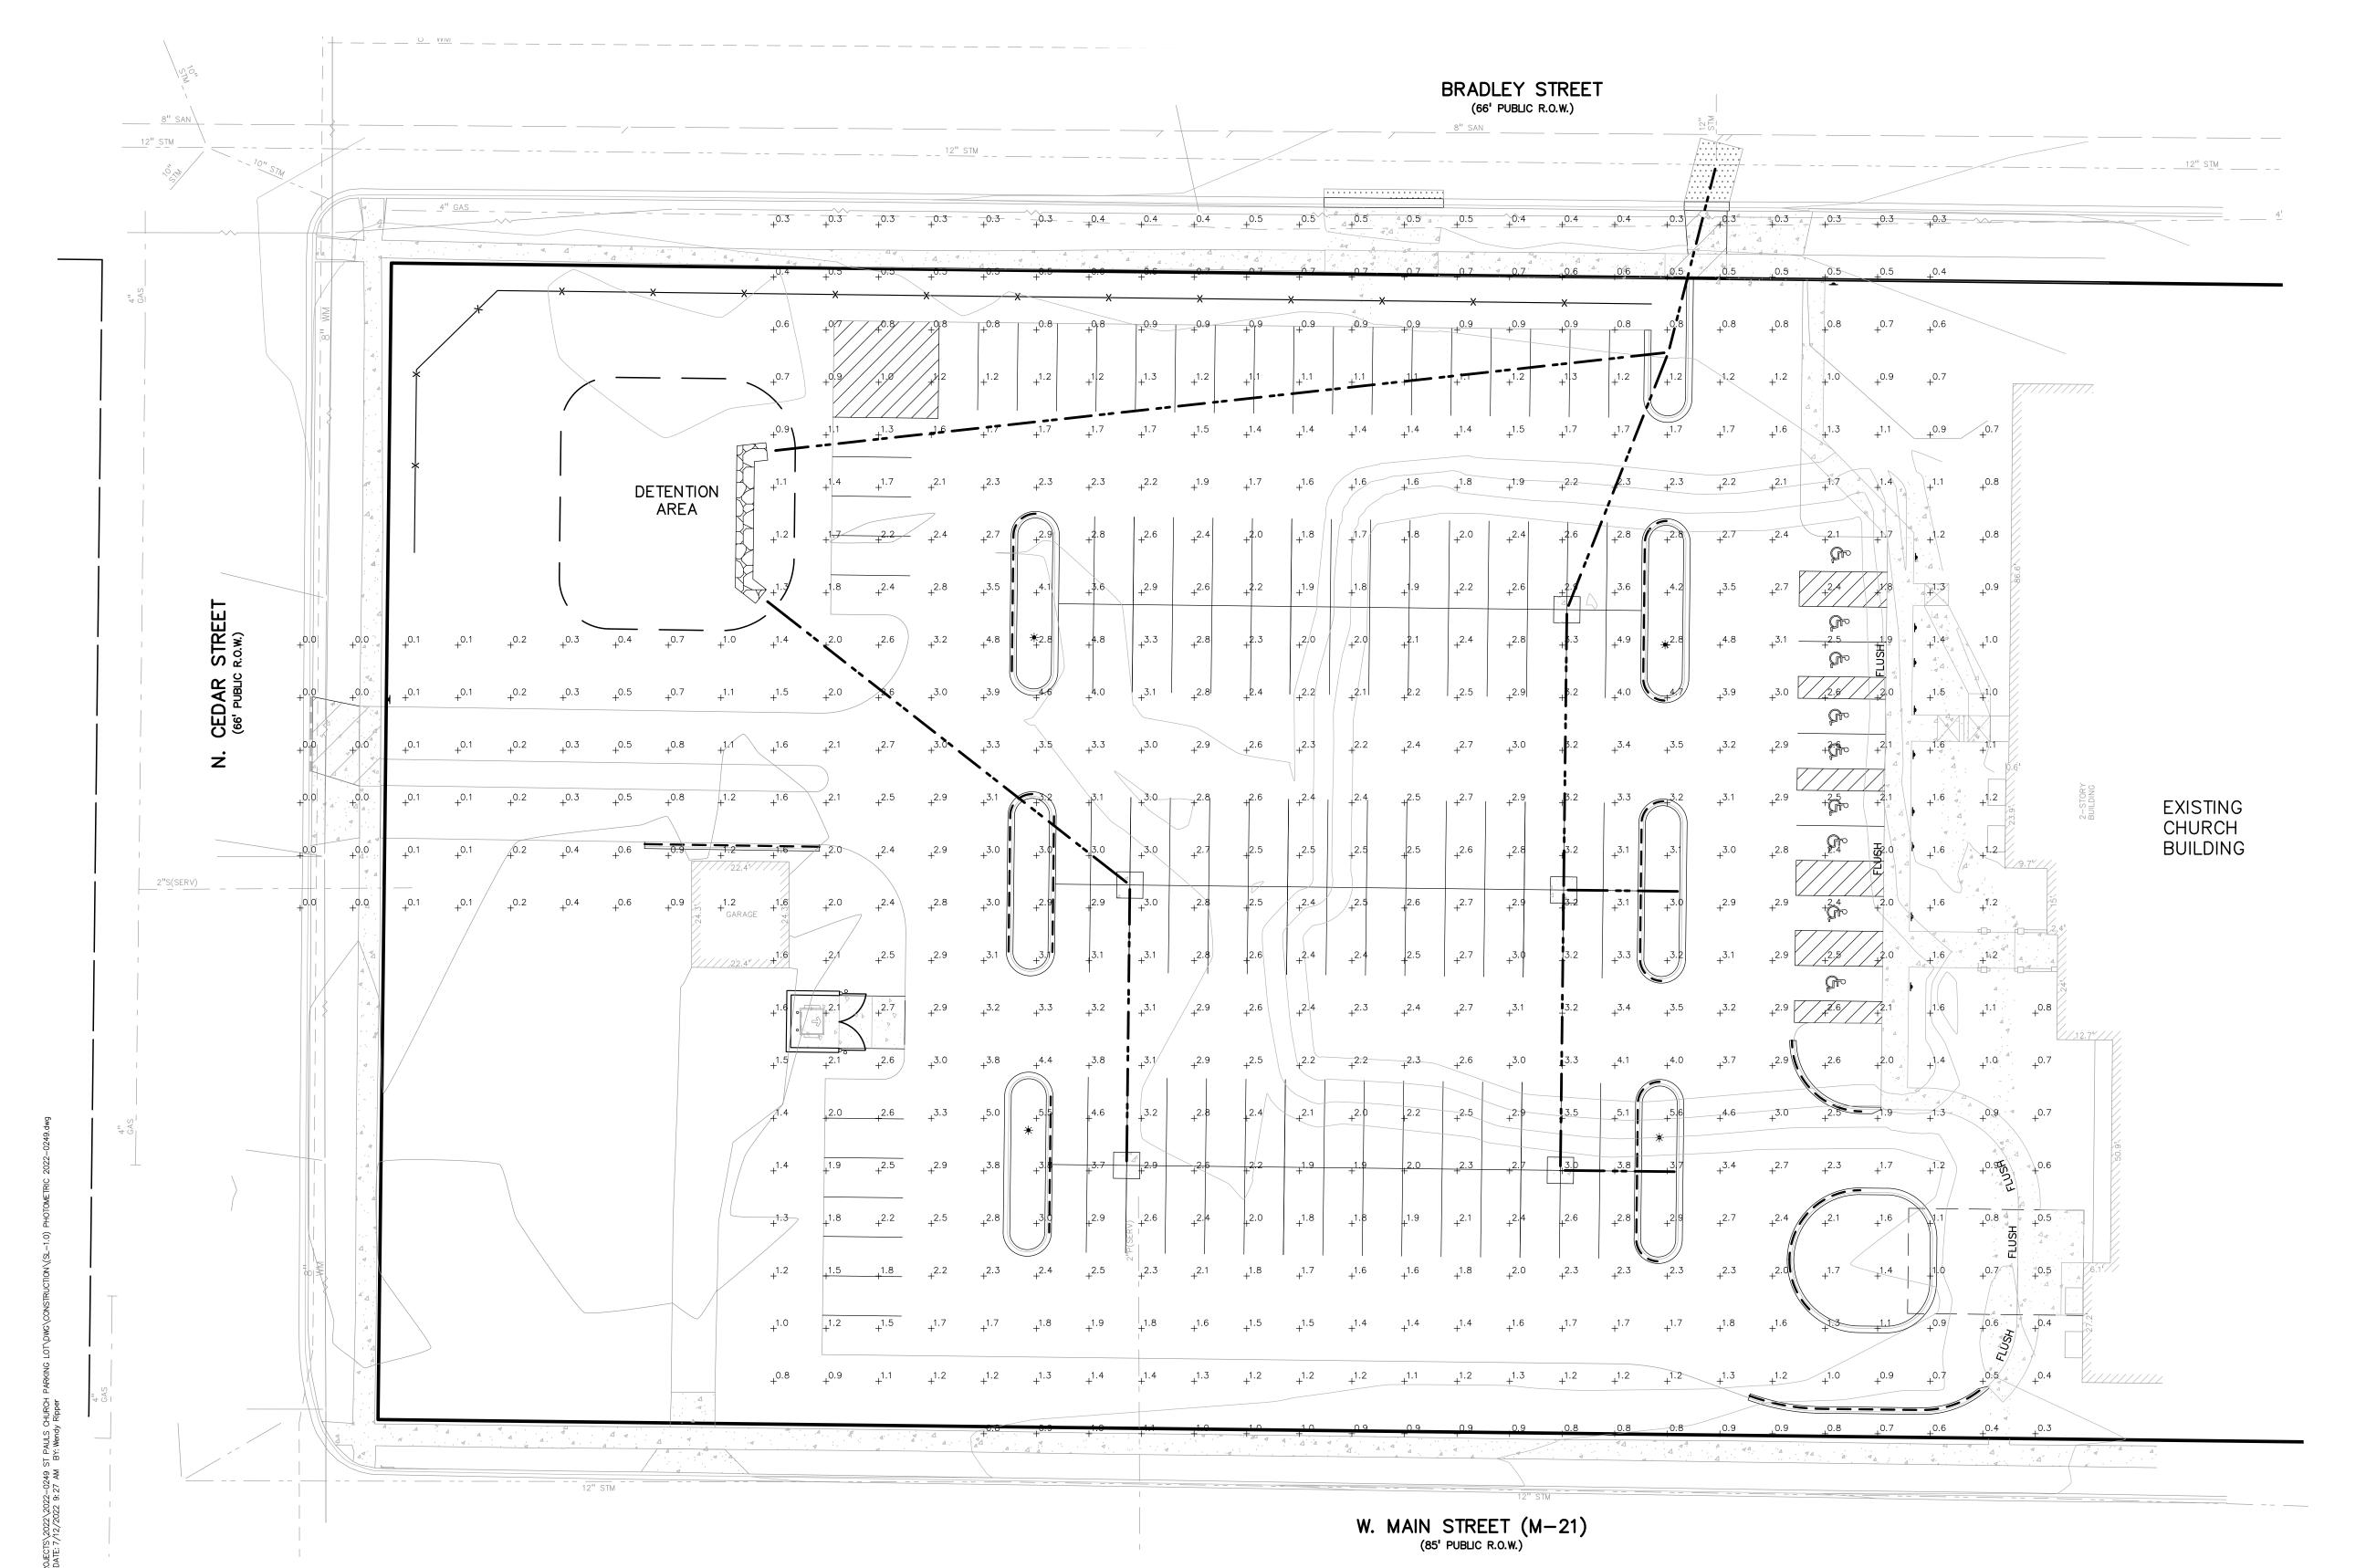


GENERAL SITE LIGHTING NOTES:

- THE LIGHTING PATTERN REPRESENTS ILLUMINATION LEVELS CALCULATED FROM LABORATORY DATA TAKEN UNDER CONTROLLED CONDITIONS IN ACCORDANCE WITH ILLUMINATING ENGINEERING SOCIETY APPROVED METHODS. ACTUAL PERFORMANCE OF ANY MANUFACTURER'S LUMINAIRE MAY VARY DUE TO VARIATION IN ELECTRICAL VOLTAGE, TOLERANCE IN LAMPS, AND OTHER VARIABLE FIELD
- 2. ALL POLES ARE TO BE MOUNTED ON CONCRETE PEDESTALS 2 FEET ABOVE GRADE AS SHOWN IN DETAIL.
- 3. ALL POLES LOCATED OUTSIDE OF THE PARKING LOT AREA SHALL BE LOCATED 5 FEET FROM BACK OF CURB OR EDGE OF SIDEWALKS AND 5 FEET FROM UTILITIES WHENEVER
- 4. SHOP DRAWINGS FOR THE ELECTRICAL WIRING OF THE FIXTURES NEED TO BE SUPPLIED BY THE CONTRACTOR AND SUBMITTED TO THE ENGINEER FOR COORDINATION OF UNDERGROUND CONDUIT AND APPROVAL OF LAYOUT.
- 5. ALL AREA LIGHT FIXTURES ARE TO BE DIRECTED AWAY FROM NEIGHBORING PROPERTIES AND ROADWAYS.
- . CONTRACTOR SHALL FURNISH, INSTALL AND CONNECT ALL MATERIALS AND EQUIPMENT FOR THIS WORK UNLESS OTHERWISE NOTED.
- . COORDINATE LIGHT FIXTURE PLACEMENT AND INSTALLATION WITH LANDSCAPE.
- 8. ALL CONDUCTORS SHALL BE IN CONDUIT.





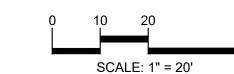



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CLIENT

ST PAUL CATHOLIC CHURCH 111 N. HOWELL ST. 0W0SSO, MI 48867

PROJECT TITLE

REVISIONS

ST PAUL'S
CHURCH
PARKING LOT

111 N. HOWELL ST.
CITY OF OWOSSO SHIAWASEE COUNTY M CITY OF OWOSSO, SHIAWASEE COUNTY, MICHIGAN

REV PER CITY

ORIGINAL ISSUE DATE: JUNE 23, 2022 DRAWING TITLE

PHOTOMETRIC PLAN

	PEA JOB NO.	2022-0249
	P.M.	TD
	DN.	WR
	DES.	WR
,	DRAWING NUMBER:	



July 14, 2022

Planning Commission City of Owosso 301 W. Main Street Owosso, Michigan 48867

Subject: 111 N. Howell Street Site Plan Review. Approximately 2.9 acres, located on the entire block

bound by Main, Bradley, Howell and Cedar Streets, Zoned B-4, General Commercial.

Attention: Ms. Tanya Buckelew, Planning and Building Director

Dear Planning Commissioners:

At your request, we have completed our review of the above site plan to develop a new parking lot for St. Paul's Church. The site consists of an entire block and previously was home to a school and a few other buildings that are being or have been torn down. The new parking lot will provide 129 new parking spaces with 9 barrier free spaces. The property is currently zoned B-4, General Business, where this use is a permitted land use.

The opinions in this report are based on a review of the site plan submitted by the applicant and conformance to ordinance standards. Please note that the applicant and their design professionals shall be responsible for the accuracy and validity of information presented with the application. In reaching a decision on the application, the Planning Commission should consider our comments along with those from other staff and consultants, additional information provided by the applicant, and your own findings based on ordinance standards as part of your deliberation.

REVIEW COMMENTS

Section 36-390 of the City of Owosso Zoning Ordinance lists the submittal requirements for site plan review. Based on our review of the proposal, discussions with the Planning and Building Director, meetings with the applicant and a visit to the site, we offer the following comments for your consideration:

Phone: 810-734-0000

Email: sprague@cibplanning.com

1. Information items. The site plan meets the informational requirements of the ordinance.

2. Area and Bulk. The proposed site was reviewed in accordance with *Article 16, Schedule of Regulations,* as described in the following table.

	Required	Provided	Comments
111 N. Howell (B-4 Zoning)			
Front Yard Building Setback	15 ft.	15 ft	In compliance

- **3. Dumpster**. The proposed dumpster meets ordinance requirements.
- **4. Parking Lot Requirements.** This requirement has been met.
- 5. Landscaping. New landscaping is proposed in the parking lot islands as well as along Main. Plant materials are compliant with the ordinance
- 6. Buffering. The ordinance requires a 4'6" buffering wall where the parking lot abuts residential areas, which are to the north of the site. Per the ordinance the Planning Commission could recommend another form of screening such as landscaping or dense shrubs to shield vehicle lights from the residential areas.
- 7. Lighting. Site lighting appears to meet the ordinance standards. It is noted that all new lighting should be shielded and fixed at 90-degree angles toward the ground, not at a 45 degree or other degree angle from the pole or building.
- **8. Other Approvals.** The proposed site plan must be reviewed and approved by the appropriate city departments, consultants, and agencies.

RECOMMENDATION

Based upon the above comments, we recommend approval of the St. Paul Church Parking Lot Site Plan, conditioned upon the following:

- 1. Addition of a screening wall, fence or Planning Commission approved landscaping materials to satisfy buffering requirements of the Zoning Ordinance;
- 2. That all light fixtures are fixed in a 90 degree to the ground, downward facing position; and
- 3. Review and approval by the appropriate city departments, consultants, and agencies.

If you have any further questions, please contact us at 810-734-0000.

Sincerely,

CIB Planning

City of Owosso Planning Commission **St. Paul Church Site Plan Review** July 14, 2022 Page 3

Justin Sprague Vice President